

DIST.	COUNTY	LOCATION CODE	POST MILES TOTAL PROJECT	SHEET NO.	TOTAL SHEETS
09	Iny	5506		6	7


  

<b>Tommy F. Lee</b>		1-19-10	REGISTERED PROFESSIONAL ENGINEER No. 18534 Exp. 12-31-10 ELEC STATE OF CALIFORNIA
REGISTERED ELECTRICAL ENGINEER	DATE		

12-09-2009	PLANS APPROVAL DATE
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The State of California or its officers or agents shall not be responsible for the accuracy or completeness of electronic copies of this plan sheet.



**1 OFFICE BUILDING ATTACHMENT DETAIL**  
NO SCALE

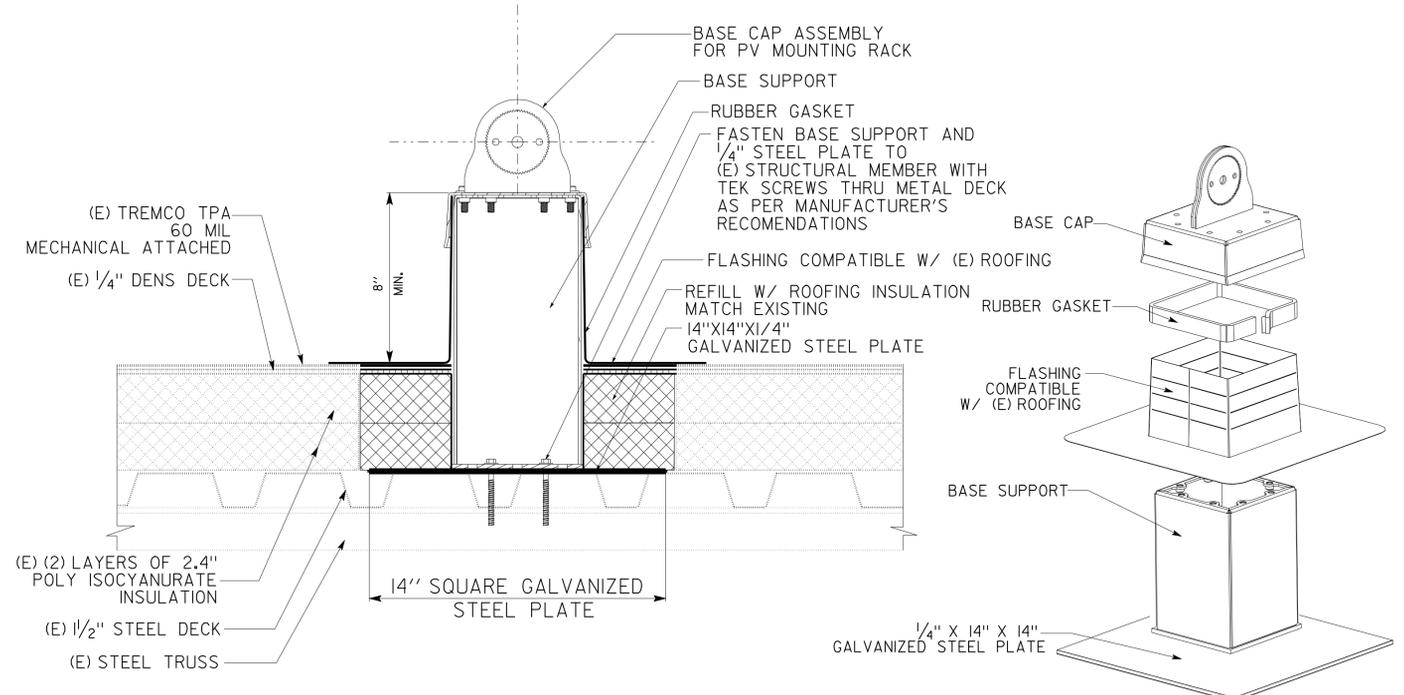
**2 ISOMETRIC**  
NO SCALE

- General notes:*
- Provide and install approved conduit support on top of the roof to support conduit system and junction boxes. Conduit support shall be one-piece and non metallic type. For conduit support details, see Detail 3 on sheet EE-4.
  - All exposed conduits shall be galvanized rigid steel, with minimum size 3/4".
  - Size conduits to allow for 50% future capacity.
  - No DC wiring except at the module connector shall be exposed.
  - Use type CGB connectors at conduit terminations to exposed conductors.
  - DC conduit/conductors between photovoltaic modules and photovoltaic Array Circuit Combiner Boxes are not shown.
  - Existing Office building and Building C roofs minimum height is approximately 9'-6".
  - For graphic symbols and abbreviations, see GP.
  - For photovoltaic rack mounting, see roof attachment Details 1 and 2 on sheet EE-4.
  - Provide and install all necessary warning labels/markings per Article 690 of California Electrical Code (CEC) and the State Fire Marshal's guideline for solar photovoltaic installation.


**CALIFORNIA STATE FIRE MARSHAL APPROVED**  
Approval of this plan does not authorize or approve any omission or deviation from applicable regulations. Final approval is subject to field inspection. The set of approved plans shall be available on the project site at all times.  
Reviewed by: *[Signature]*  
**MIKE TANAKA**  
Approval date: 12-09-09

*Note:*  
① 2" C, MC, with DC conductors and equipment grounding conductor to Utility Interactive Inverter Cabinet. For continuation, see sheet EE-1.

① REVISED PER ADDENDUM NO. 1 DATED 02-17-10

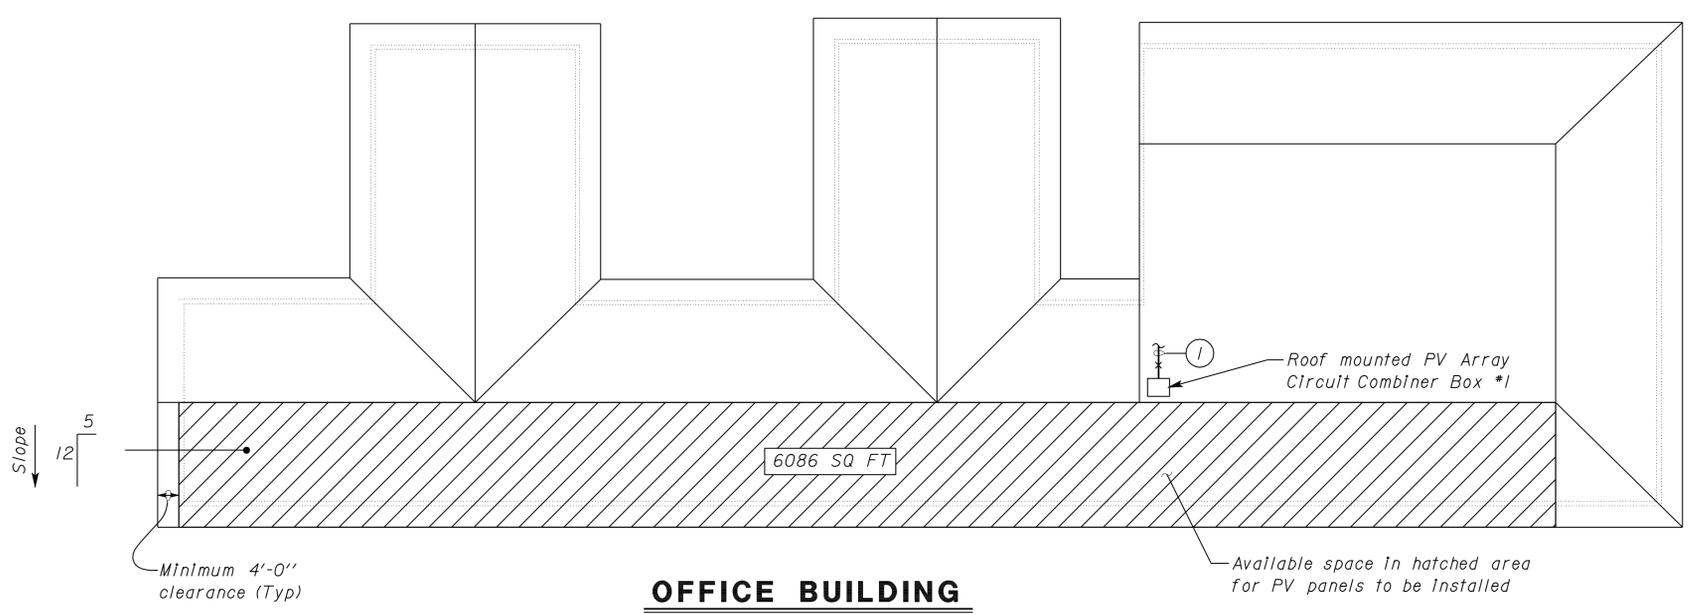

**OFFICE BUILDING**

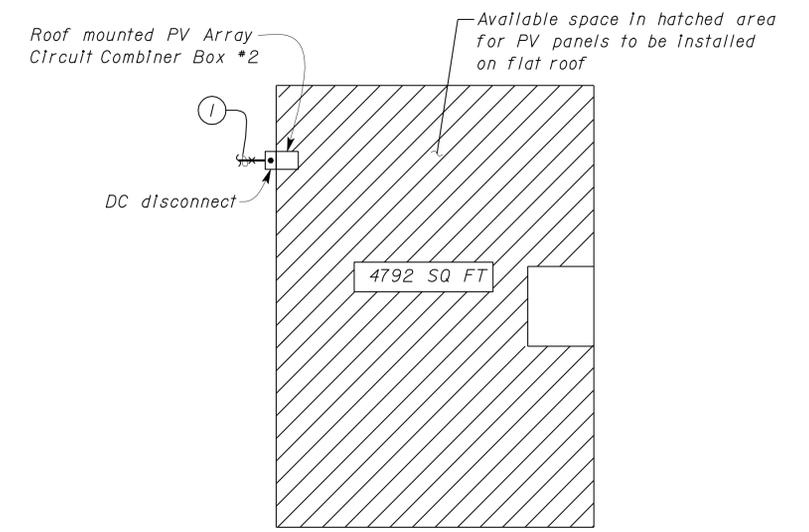

**BUILDING C**

**ROOF PLAN**  
SCALE 1/16" = 1'-0"

THIS DRAWING ACCURATE FOR ELECTRICAL WORK ONLY

DESIGN	BY	Tommy F. Lee	CHECKED	Jesse Sandhu	STATE OF CALIFORNIA DEPARTMENT OF TRANSPORTATION	DIVISION OF ENGINEERING SERVICES ELECTRICAL-MECHANICAL-WATER AND WASTEWATER DESIGN	BRIDGE NO. 48M5506 POST MILE	BISHOP OFFICE BUILDING PHOTOVOLTAIC SYSTEM	SHEET <b>EE-3</b>
	DETAILS	BY	Dall Zhou	CHECKED					
QUANTITIES	BY	Tommy F. Lee	CHECKED	Jesse Sandhu	ORIGINAL SCALE IN INCHES FOR REDUCED PLANS		CU 09124 EA OAA011	DISREGARD PRINTS BEARING EARLIER REVISION DATES	REVISION DATES (PRELIMINARY STAGE ONLY)


DOES SD Imperial Rev. 1/07

0 1 2 3

9/20/09 1/19/10

SHEET OF

ee\_3.dgn

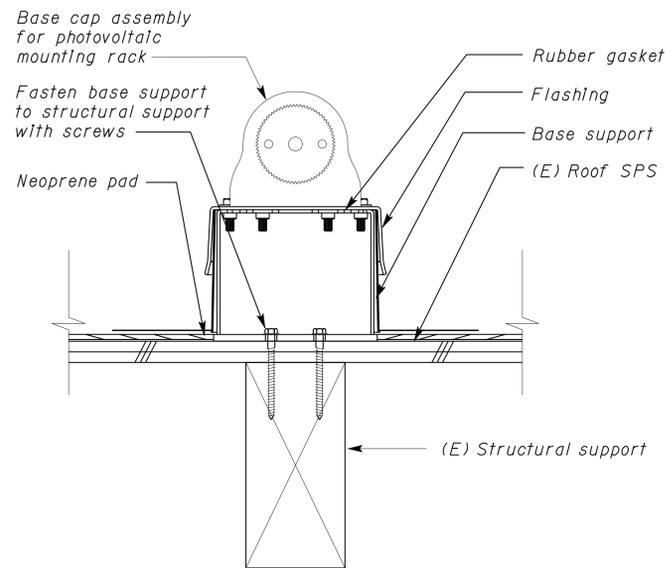

**1 WOOD-NO INSULATION AT BUILDING C**  
NO SCALE

**CALIFORNIA STATE FIRE MARSHAL APPROVED**  
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Reviewed by: *[Signature]*  
MIKE TANAKA  
Approval date: 12-09-09

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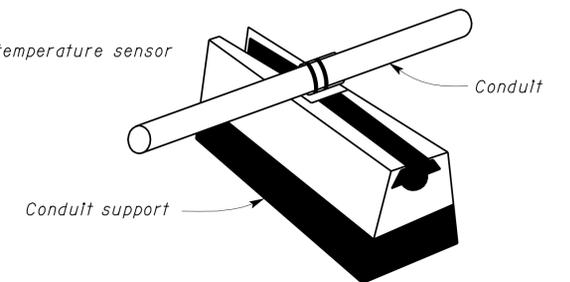
*Tommy F. Lee*  
REGISTERED ELECTRICAL ENGINEER DATE 1-19-10

REGISTERED PROFESSIONAL ENGINEER  
TOMMY F. LEE  
No. 18534  
Exp. 12-31-10  
ELEC  
STATE OF CALIFORNIA


12-09-2009  
PLANS APPROVAL DATE

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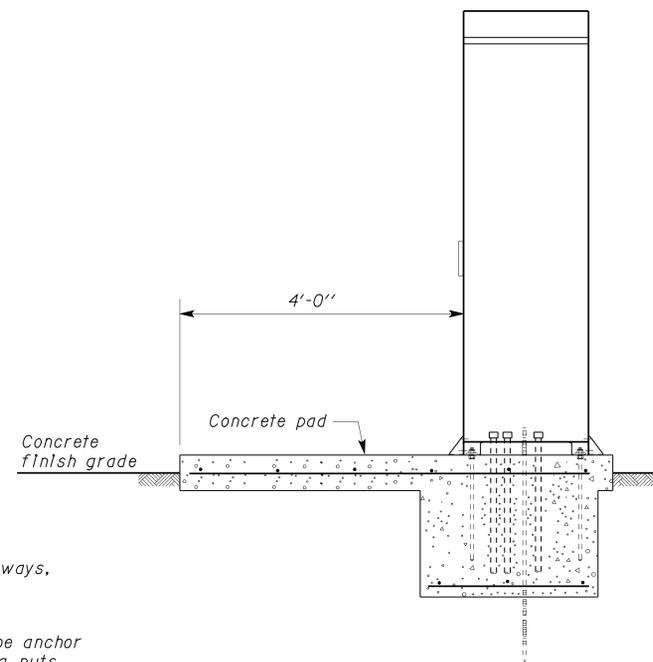
- Notes:**
- 3" C, RSC, five conductors; three phase, one neutral and one equipment grounding conductor.
  - 2" C, RSC, with DC conductors and equipment grounding conductor from photovoltaic Array Circuit Combiner Box on the roof.
  - 1/2" C, RSC, one RS485 modbus cable.
  - 1/2" C, RSC, 2\*12, 1\*12G.
  - 1/2" C, RSC, Category 6 cable to existing TTB inside the Telephone Cabinet.
  - 2" C, RSC, conductors as required.
  - 3/4" C, shielded data conductors/cable to cell temperature sensor at photovoltaic module.




**3 ROOF MOUNTED CONDUIT SUPPORT**  
NO SCALE

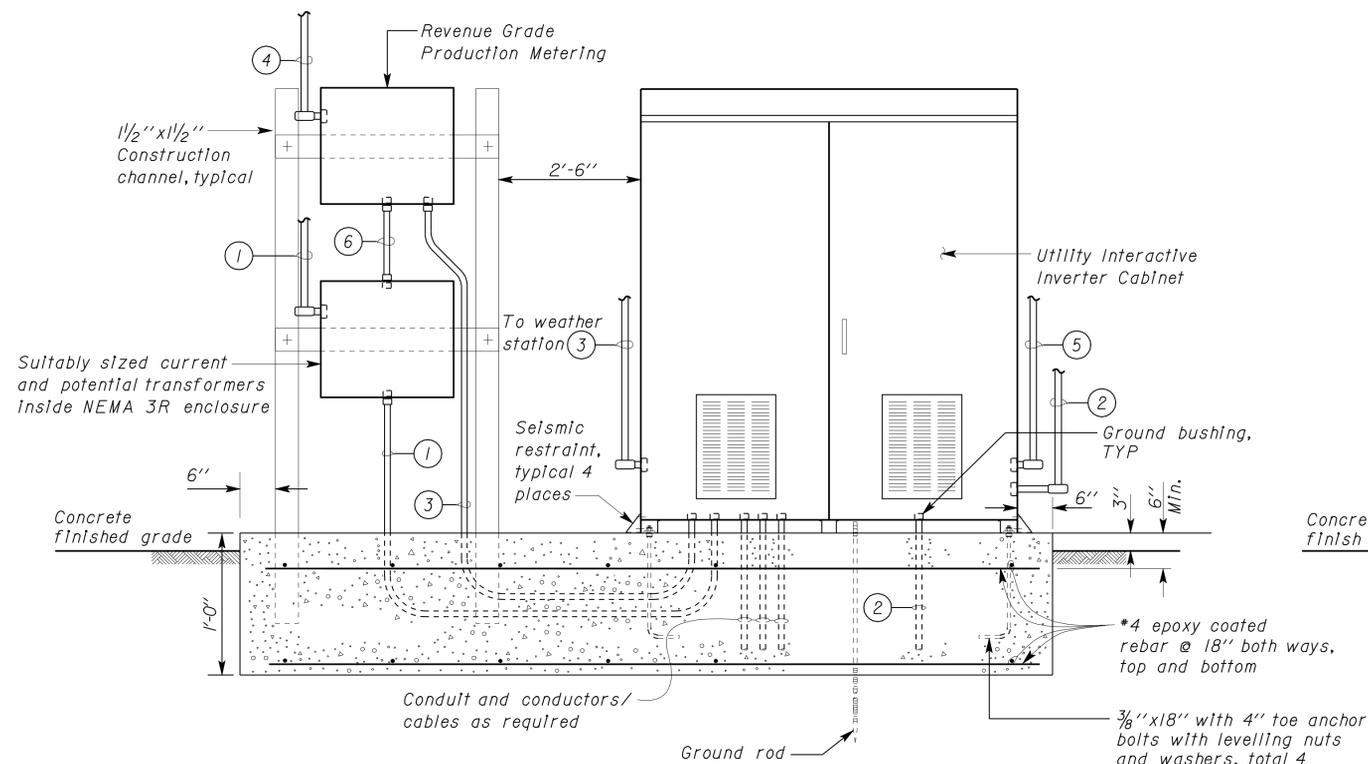

**A ELEVATION**  
NO SCALE



**SIDE VIEW**

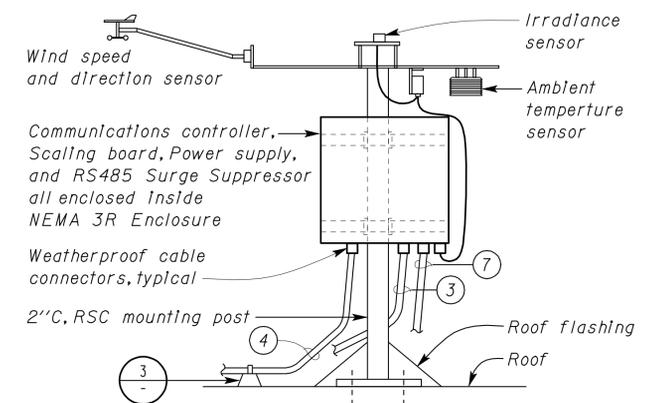

**4 WEATHER STATION**  
NO SCALE

REVISD PER ADDENDUM NO. 1 DATED 02-17-10

DESIGN	BY Tommy F. Lee	CHECKED Jesse Sandhu	STATE OF CALIFORNIA DEPARTMENT OF TRANSPORTATION	DIVISION OF ENGINEERING SERVICES ELECTRICAL-MECHANICAL-WATER AND WASTEWATER DESIGN	BRIDGE NO.	BISHOP OFFICE BUILDING PHOTOVOLTAIC SYSTEM	SHEET	
DETAILS	BY Dall Zhou	CHECKED Tommy F. Lee			48M5506		ELEVATION AND DETAILS	EE-4
QUANTITIES	BY Tommy F. Lee	CHECKED Jesse Sandhu			POST MILE			
ORIGINAL SCALE IN INCHES FOR REDUCED PLANS			CU 09124	EA 0AA011	DISREGARD PRINTS BEARING EARLIER REVISION DATES		REVISION DATES (PRELIMINARY STAGE ONLY)	SHEET OF