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THE STANDARD PLANS LIST APPLICABLE TO THIS CONTRACT IS INCLUDED IN THE NOTICE TO BIDDERS AND SPECIAL PROVISIONS BOOK.

STATE OF CALIFORNIA  
DEPARTMENT OF TRANSPORTATION



IM-015-4(206)E

PROJECT PLANS FOR CONSTRUCTION ON  
STATE HIGHWAY

IN SAN DIEGO COUNTY

ABOUT 11.2 MILES NORTH OF ESCONDIDO  
FROM 0.8 MILE SOUTH OF ESCONDIDO HIGHWAY OVERCROSSING  
TO SAN LUIS REY RIVER BRIDGE

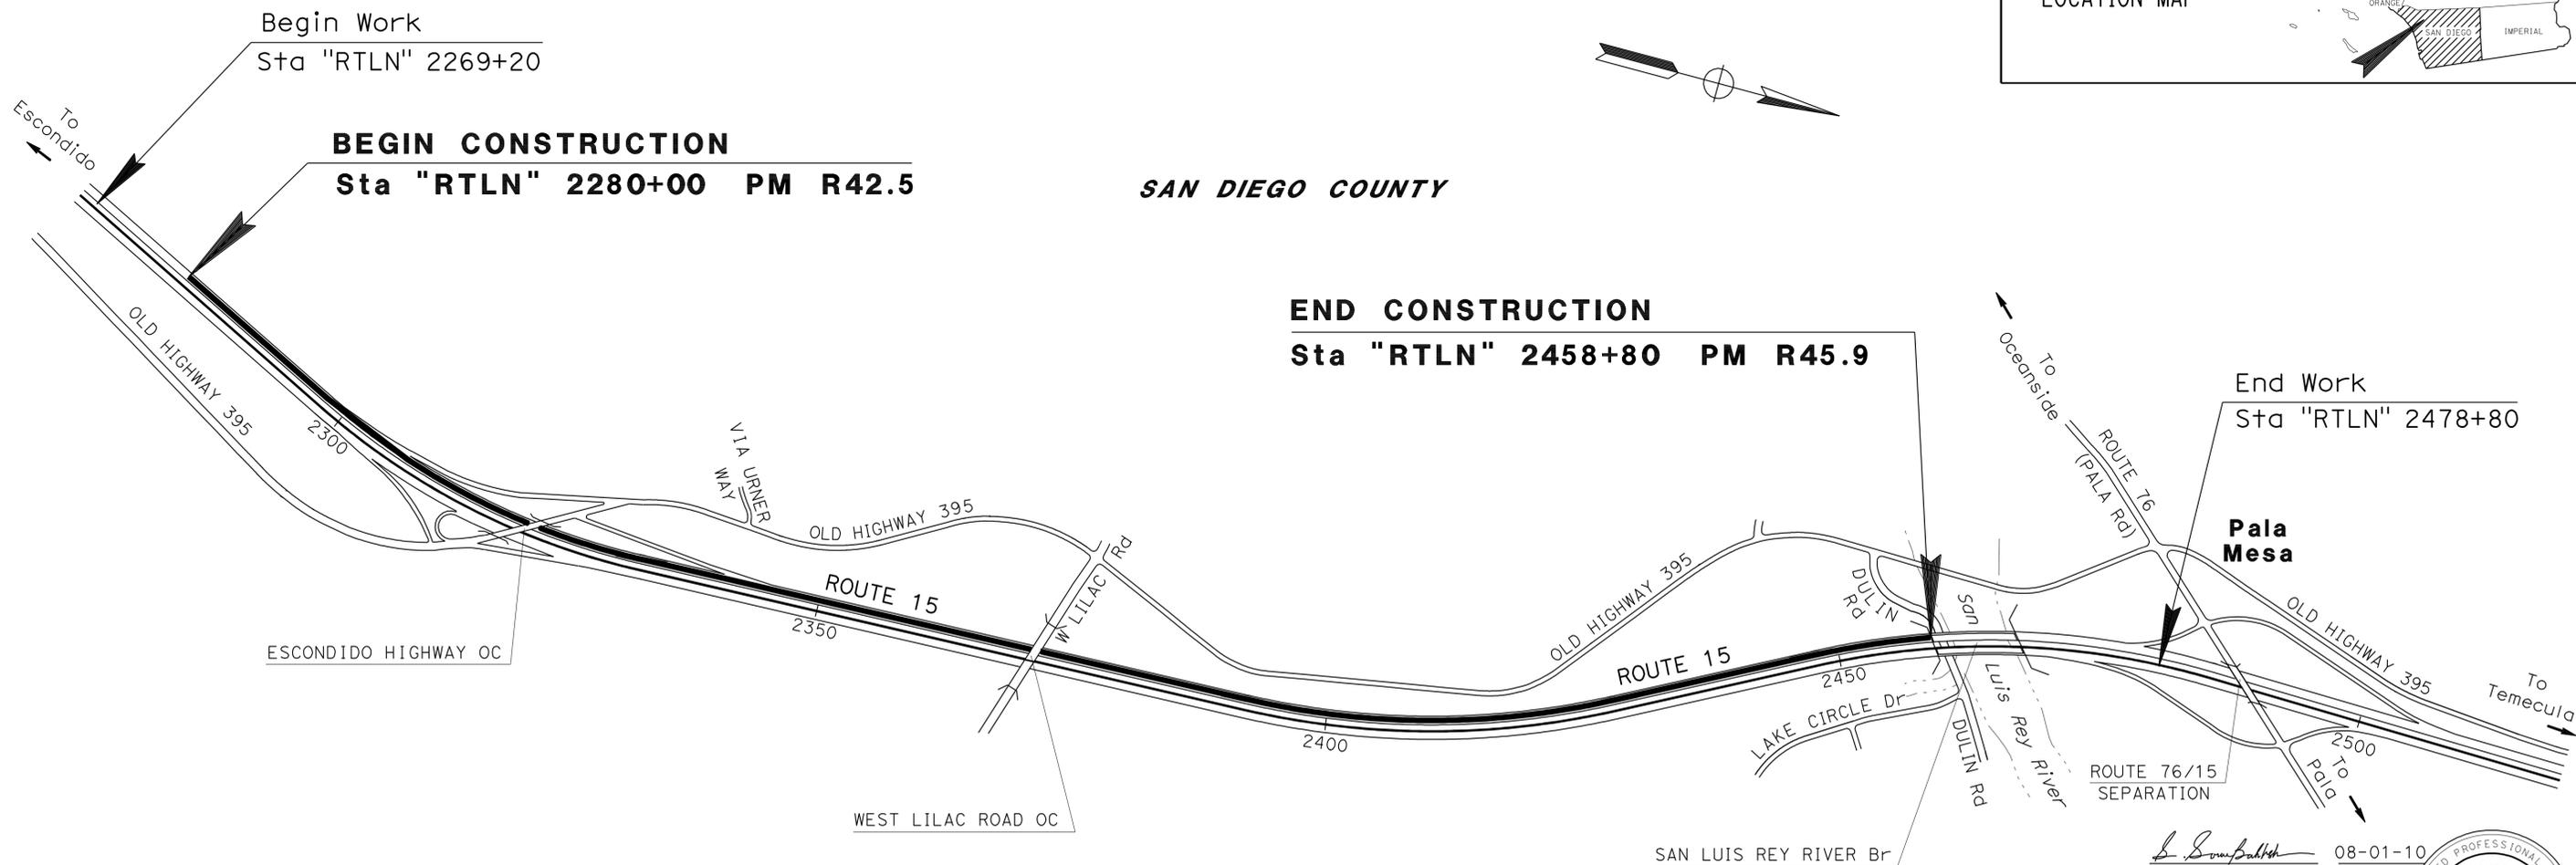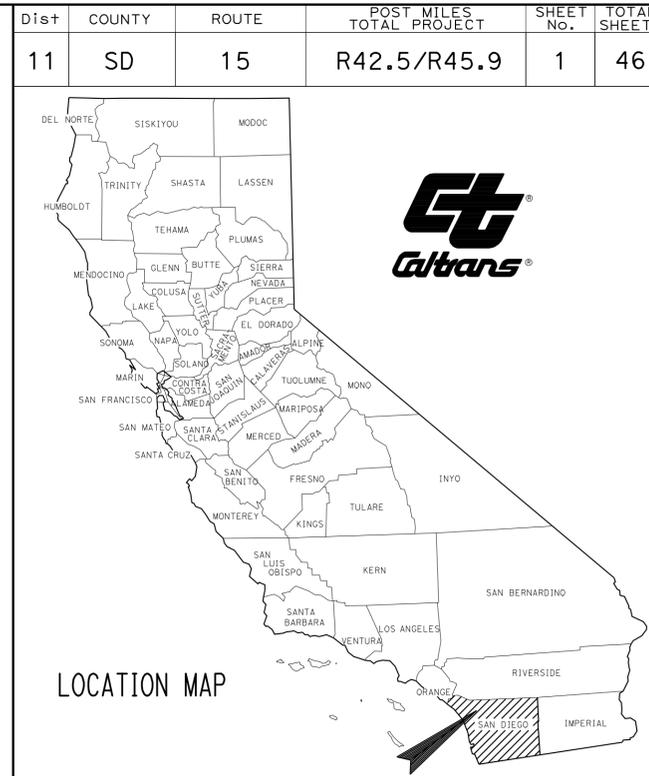TO BE SUPPLEMENTED BY STANDARD PLANS DATED MAY 2006



PROJECT MANAGER  
CHRIS M THOMAS

DESIGN ENGINEER  
SHAHRAR SOROURBAKHSH

*S. Sorourbakhsh* 08-01-10  
PROJECT ENGINEER DATE  
REGISTERED CIVIL ENGINEER



October 4, 2010  
PLANS APPROVAL DATE  
THE STATE OF CALIFORNIA OR ITS OFFICERS OR AGENTS SHALL NOT BE RESPONSIBLE FOR THE ACCURACY OR COMPLETENESS OF SCANNED COPIES OF THIS PLAN SHEET.

THE CONTRACTOR SHALL POSSESS THE CLASS (OR CLASSES) OF LICENSE AS SPECIFIED IN THE "NOTICE TO BIDDERS."

NO SCALE

CONTRACT No.	11-289704
PROJECT ID	1100020026

STATE OF CALIFORNIA - DEPARTMENT OF TRANSPORTATION  
**Caltrans**  
 DESIGN  
 FUNCTIONAL SUPERVISOR: CHRIS M THOMAS  
 CALCULATED/DESIGNED BY: SHAHRIAR SOROUBAKHSH  
 CHECKED BY: GARRY WILLIAMS  
 REVISIONS: REVISED BY: DATE  
 REVISED BY: DATE

**NOTES:**

- DIMENSIONS OF PAVEMENT STRUCTURES (STRUCTURAL SECTIONS) ARE SUBJECT TO TOLERANCES SPECIFIED IN THE STANDARD SPECIFICATIONS.
- SUPERELEVATION AS SHOWN OR AS DIRECTED BY THE ENGINEER.
- EXISTING UTILITIES HAVE NOT BEEN PLOTTED ON THESE PLANS.
- FOG SEAL COAT SHALL BE APPLIED TO ALL HMA SURFACES EXCEPT TRAVELED WAY AND DETOURS.
- HMA-A= HOT MIX ASPHALT (TYPE-A)
- FOR LOCATIONS AND LIMITS OF COLD PLANE SEE LAYOUT AND QUANTITY SHEETS
- ESA = ENVIRONMENTALLY SENSITIVE AREA

**LEGEND:**

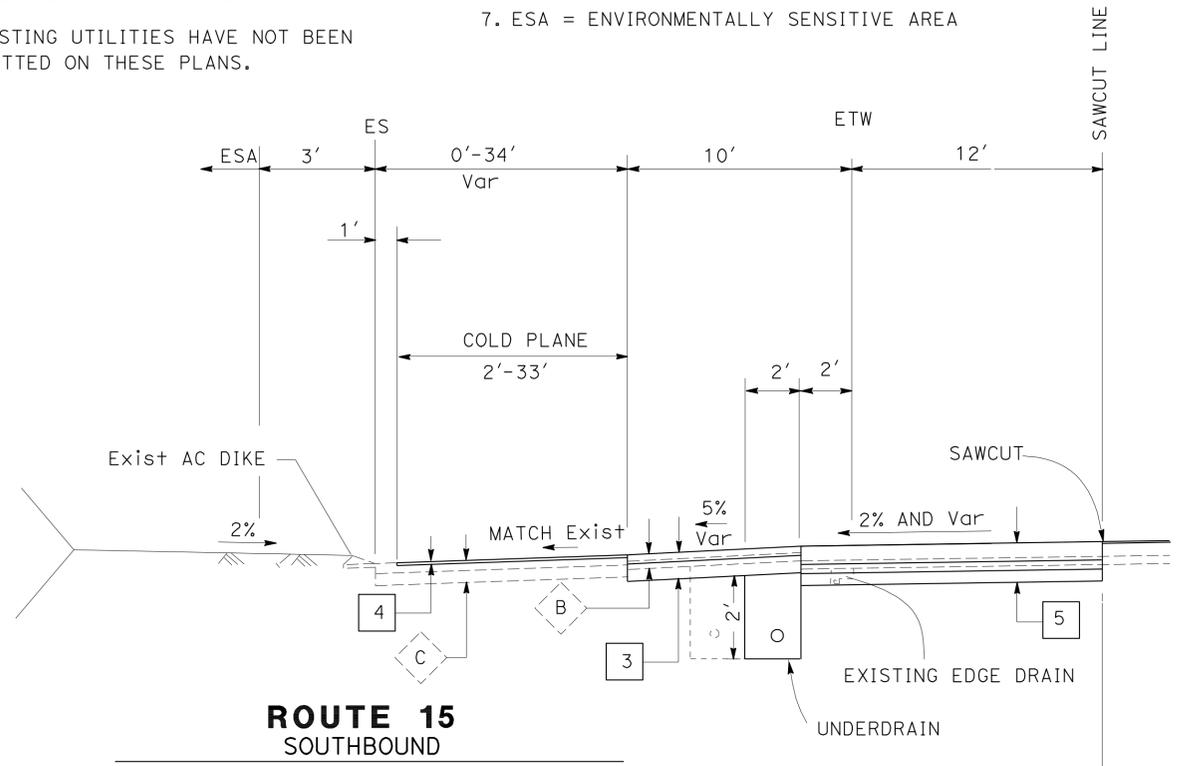
- |   |   |       |
|---|---|-------|
| 1 | 1.00' JPCP<br>0.50' HMA-A<br>0.65' AB-CLASS 2   | Exist |
| 2 | 0.35' HMA-A<br>0.95' AB-CLASS 2   | Exist |
| 3 | 0.50' HMA-A<br>0.95' AB-CLASS 2   | Exist |
| 4 | 0.15' COLD PLANE AC PAVEMENT<br>0.15' HMA-A   | Exist |
| 5 | 1.00' CONCRETE PAVEMENT<br>(RAPID STRENGTH CONCRETE)<br>0.50' HMA-A<br>0.65' AB-CLASS 2 | Exist |
- A 0.80' PCC  
0.45' CTB  
 B 0.35' AC  
0.45' AB  
 C 0.55' AC  
0.65' AB

Dist	COUNTY	ROUTE	POST MILES TOTAL PROJECT	SHEET No.	TOTAL SHEETS
11	SD	15	R42.5/R45.9	2	46


REGISTERED CIVIL ENGINEER: *Shahriar Sorourbaksh*  
 DATE: 08-01-10  
 PLANS APPROVAL DATE: 10-04-10  
 No. 52814  
 Exp. 12-31-11  
 CIVIL  
 THE STATE OF CALIFORNIA OR ITS OFFICERS OR AGENTS SHALL NOT BE RESPONSIBLE FOR THE ACCURACY OR COMPLETENESS OF SCANNED COPIES OF THIS PLAN SHEET.

**DESIGN DESIGNATION (SB ROUTE 15)**

ADT (2010)	135,000	D	63%
ADT (2030)	235,000	T	10%
DHV	16,700	V	70 MPH
ESAL	33,314,600	TI	15.5



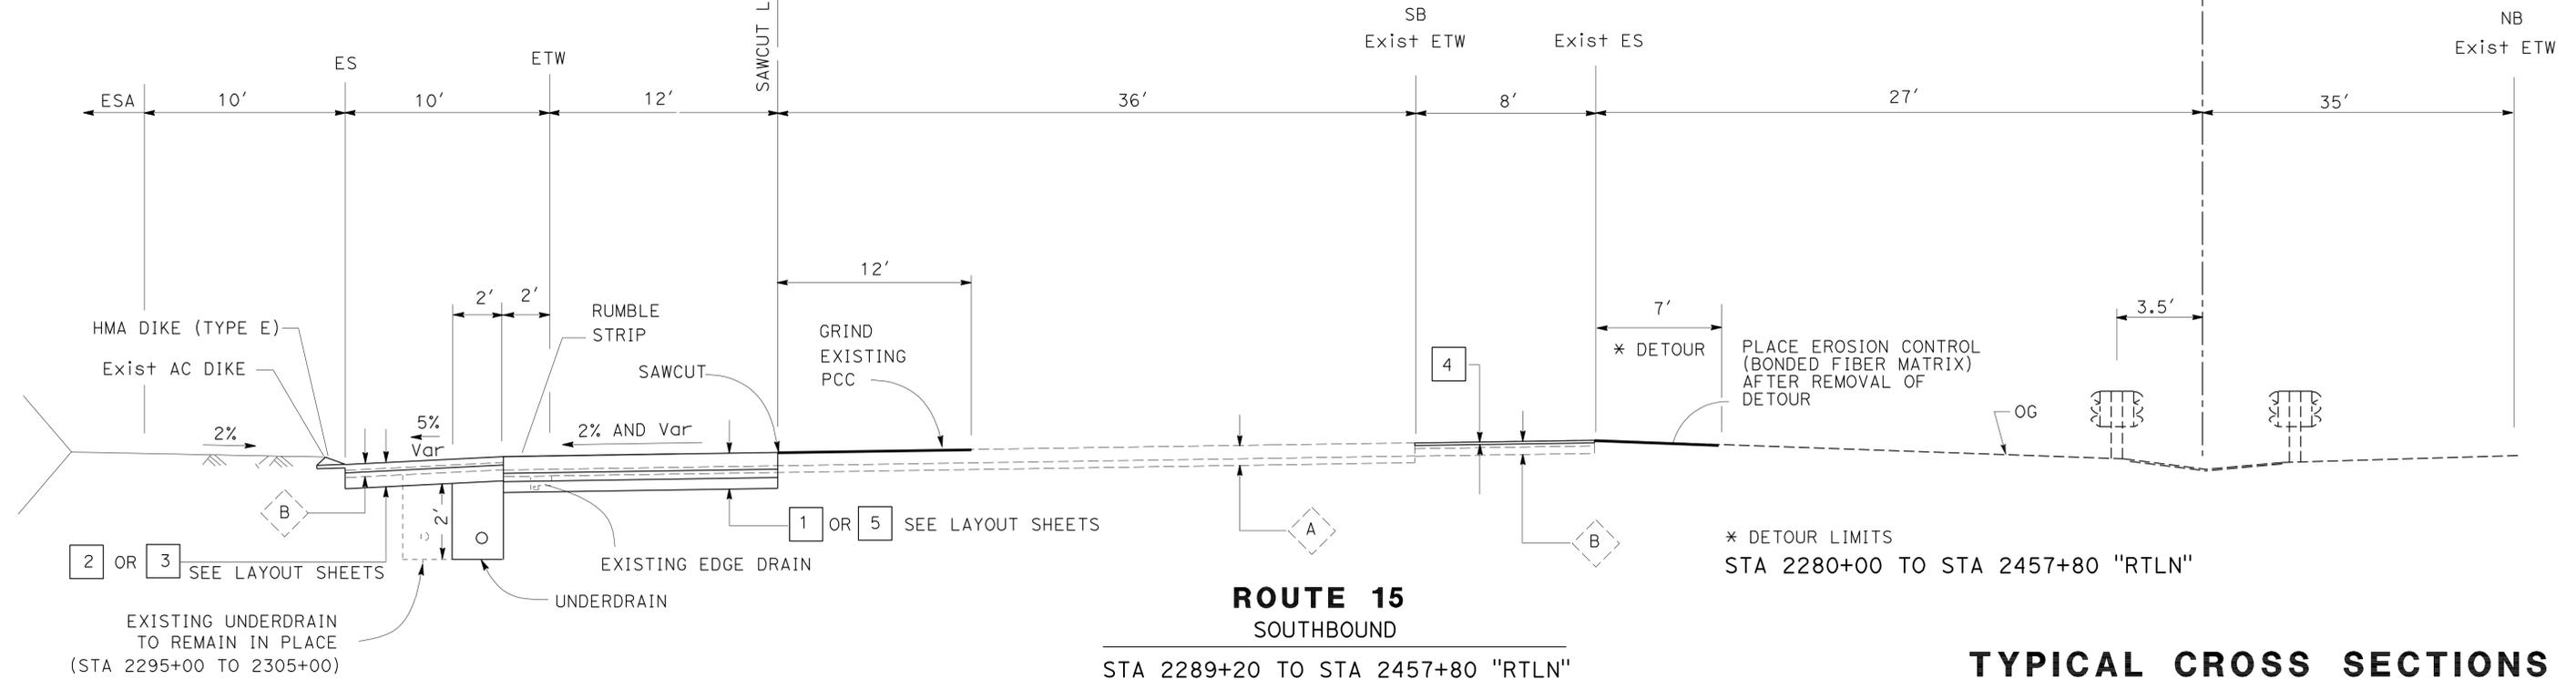**ROUTE 15 SOUTHBOUND**  
 STA 2299+10 TO STA 2303+75 "RTLN"  
 STA 2342+80 TO STA 2345+80 "RTLN"



**ROUTE 15 SOUTHBOUND**  
 STA 2289+20 TO STA 2457+80 "RTLN"

**TYPICAL CROSS SECTIONS**

NO SCALE

**X-1**



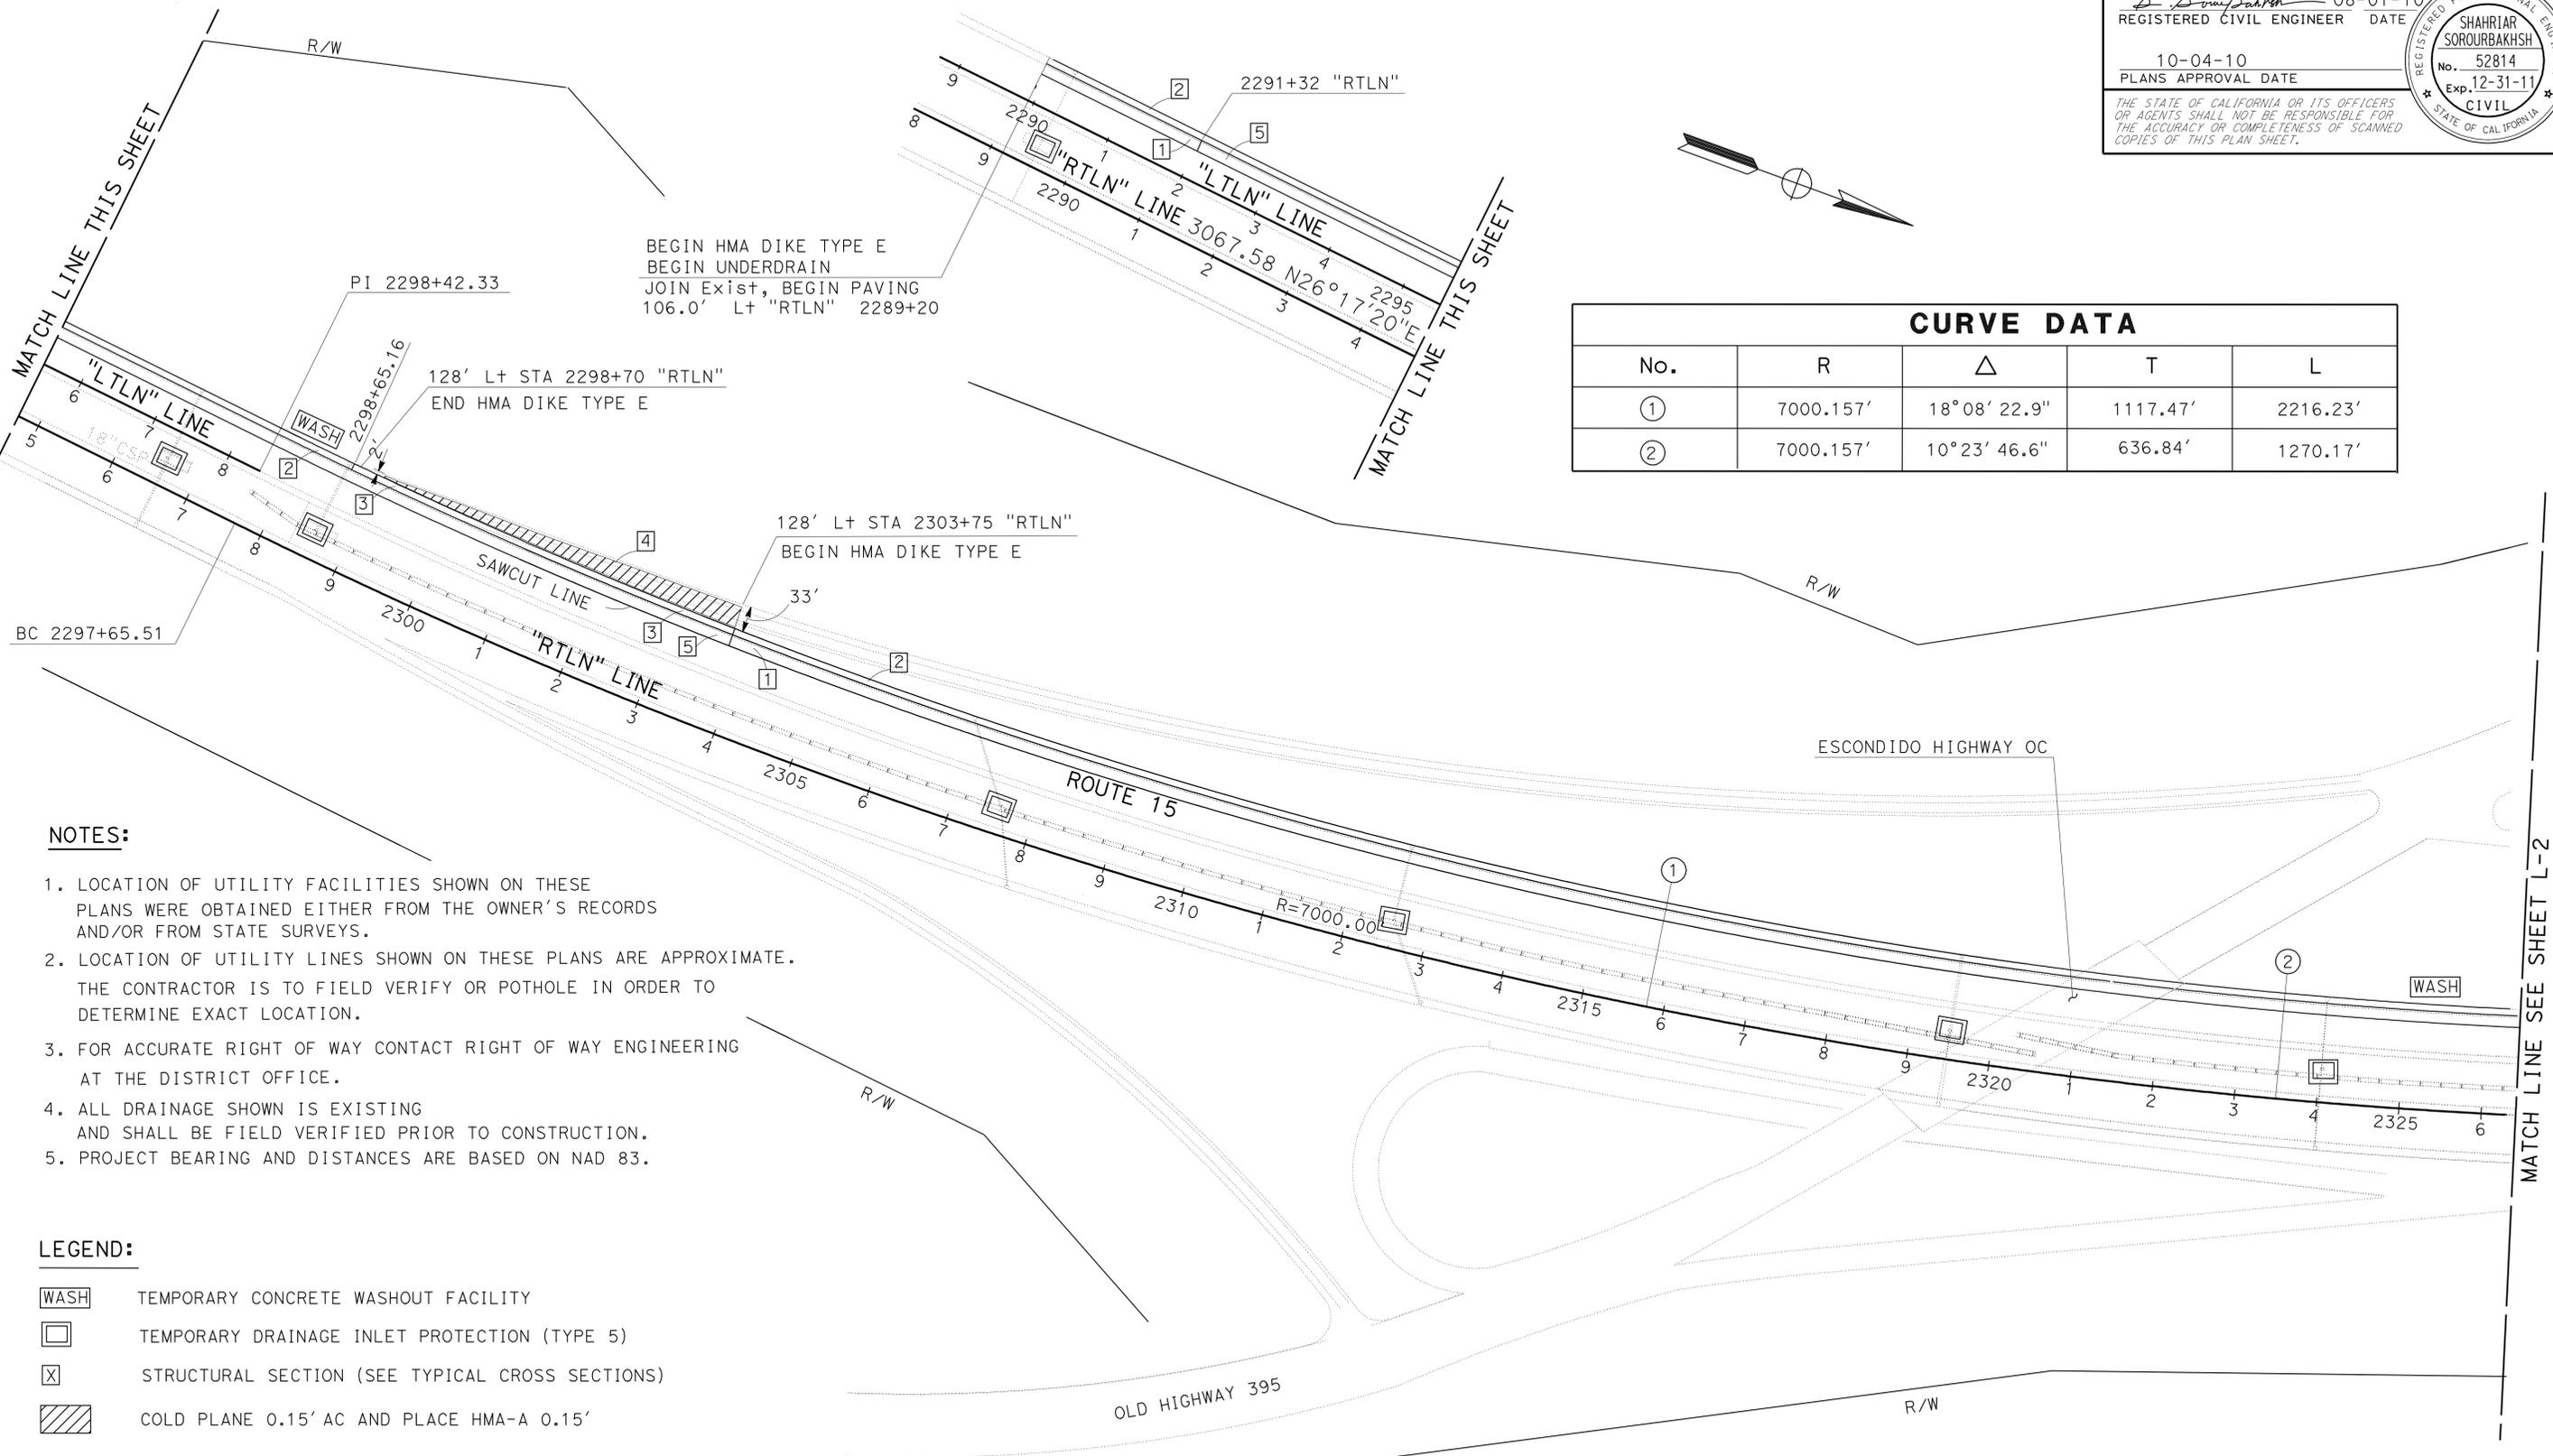
Dist	COUNTY	ROUTE	POST MILES TOTAL PROJECT	SHEET No.	TOTAL SHEETS
11	SD	15	R42.5/R45.9	4	46

08-01-10  
 REGISTERED CIVIL ENGINEER DATE  
 10-04-10  
 PLANS APPROVAL DATE

REGISTERED PROFESSIONAL ENGINEER  
 SHAHRIAR SOROURBAKHS  
 No. 52814  
 Exp. 12-31-11  
 CIVIL  
 STATE OF CALIFORNIA

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CURVE DATA				
No.	R	Δ	T	L
①	7000.157'	18°08' 22.9"	1117.47'	2216.23'
②	7000.157'	10°23' 46.6"	636.84'	1270.17'



- NOTES:**
1. LOCATION OF UTILITY FACILITIES SHOWN ON THESE PLANS WERE OBTAINED EITHER FROM THE OWNER'S RECORDS AND/OR FROM STATE SURVEYS.
  2. LOCATION OF UTILITY LINES SHOWN ON THESE PLANS ARE APPROXIMATE. THE CONTRACTOR IS TO FIELD VERIFY OR POTHOLE IN ORDER TO DETERMINE EXACT LOCATION.
  3. FOR ACCURATE RIGHT OF WAY CONTACT RIGHT OF WAY ENGINEERING AT THE DISTRICT OFFICE.
  4. ALL DRAINAGE SHOWN IS EXISTING AND SHALL BE FIELD VERIFIED PRIOR TO CONSTRUCTION.
  5. PROJECT BEARING AND DISTANCES ARE BASED ON NAD 83.

- LEGEND:**
- WASH TEMPORARY CONCRETE WASHOUT FACILITY
  - TEMPORARY DRAINAGE INLET PROTECTION (TYPE 5)
  - STRUCTURAL SECTION (SEE TYPICAL CROSS SECTIONS)
  - COLD PLANE 0.15' AC AND PLACE HMA-A 0.15'

Exist UTILITIES	TYPE	OWNER
	ELECTRIC LINE	SDG&E

STATE OF CALIFORNIA - DEPARTMENT OF TRANSPORTATION  
**Caltrans**  
 DESIGN  
 FUNCTIONAL SUPERVISOR: CHRIS M THOMAS  
 CALCULATED/DESIGNED BY: GARRY WILLIAMS  
 CHECKED BY:  
 SHHRIAR SOROURBAKHS  
 REVISED BY: DATE REVISD:

MATCH LINE SEE SHEET L-2

**LAYOUT**  
**L-1**

SCALE: 1"=100'

Dist	COUNTY	ROUTE	POST MILES TOTAL PROJECT	SHEET NO.	TOTAL SHEETS
11	SD	15	R42.5/R45.9	5	46



08-01-10  
 REGISTERED CIVIL ENGINEER DATE  
 10-04-10  
 PLANS APPROVAL DATE

REGISTERED PROFESSIONAL ENGINEER  
 SHAHRIAR SOROURBAKHS  
 No. 52814  
 Exp. 12-31-11  
 CIVIL  
 STATE OF CALIFORNIA

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 COPIES OF THIS PLAN SHEET.

**NOTE:**

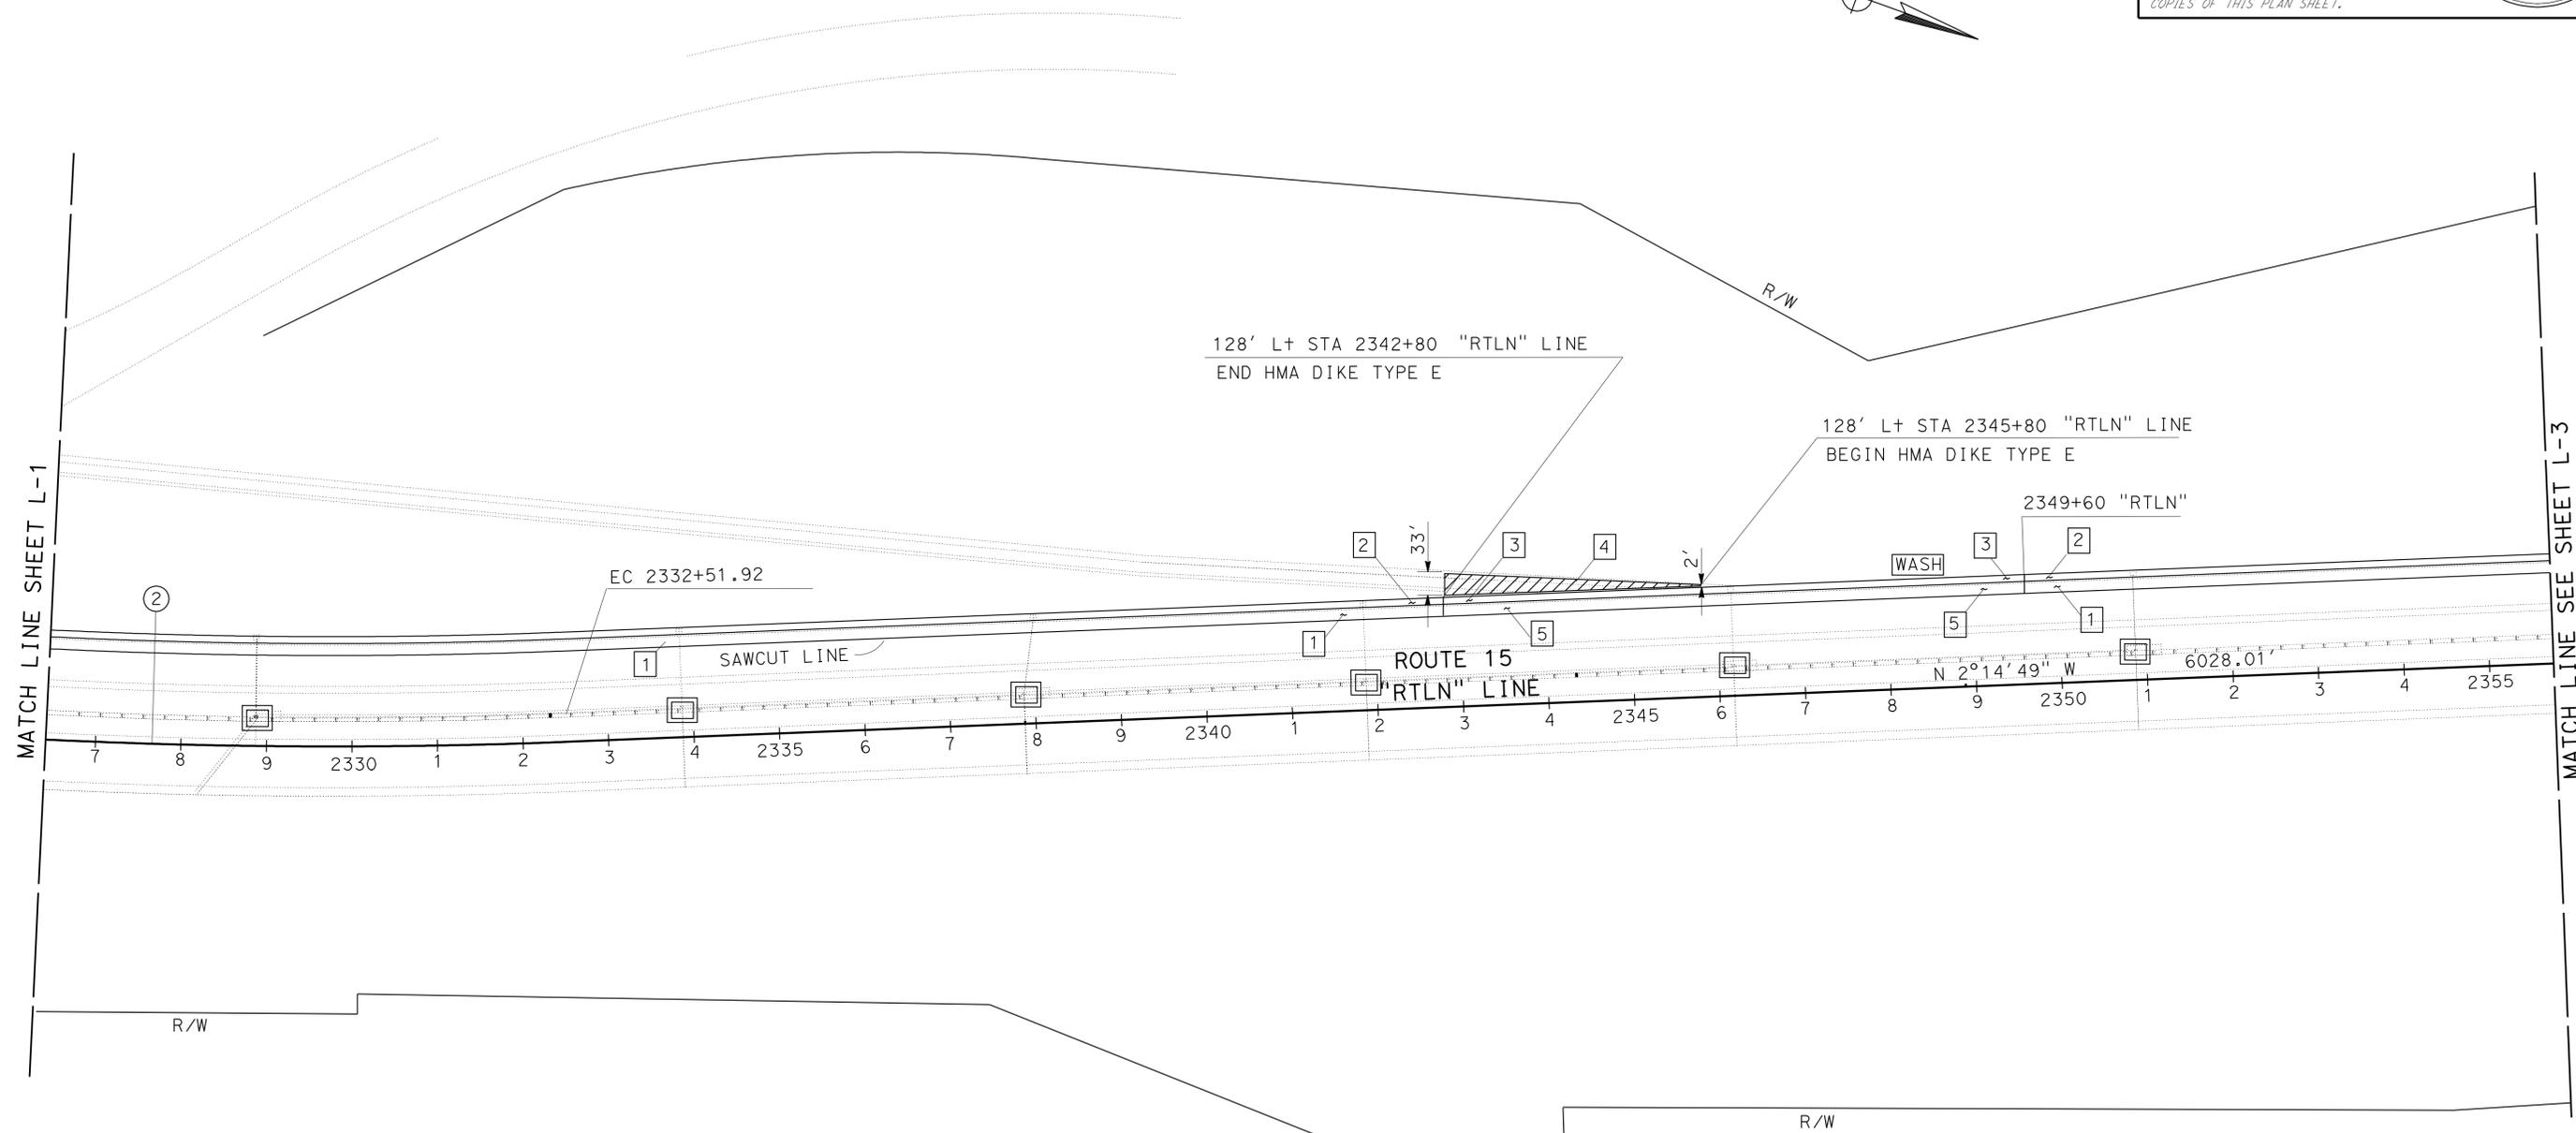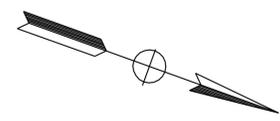1. FOR ACCURATE RIGHT OF WAY CONTACT RIGHT OF WAY ENGINEERING AT THE DISTRICT OFFICE.



STATE OF CALIFORNIA - DEPARTMENT OF TRANSPORTATION  
**Caltrans**  
 DESIGN

FUNCTIONAL SUPERVISOR  
 CHRIS M THOMAS

CALCULATED/DESIGNED BY  
 CHECKED BY

SHAHRIAR SOROURBAKHS  
 GARRY WILLIAMS

REVISED BY  
 DATE REVISED

CURVE DATA				
No.	R	Δ	T	L
②	7000.157'	10° 23' 46.6"	636.84'	1270.17'

**LAYOUT**

SCALE: 1"=100' **L-2**

DIST	COUNTY	ROUTE	POST MILES TOTAL PROJECT	SHEET No.	TOTAL SHEETS
11	SD	15	R42.5/R45.9	6	46

<i>S. Sorourbaksh</i>	08-01-10
REGISTERED CIVIL ENGINEER	DATE
10-04-10	
PLANS APPROVAL DATE	

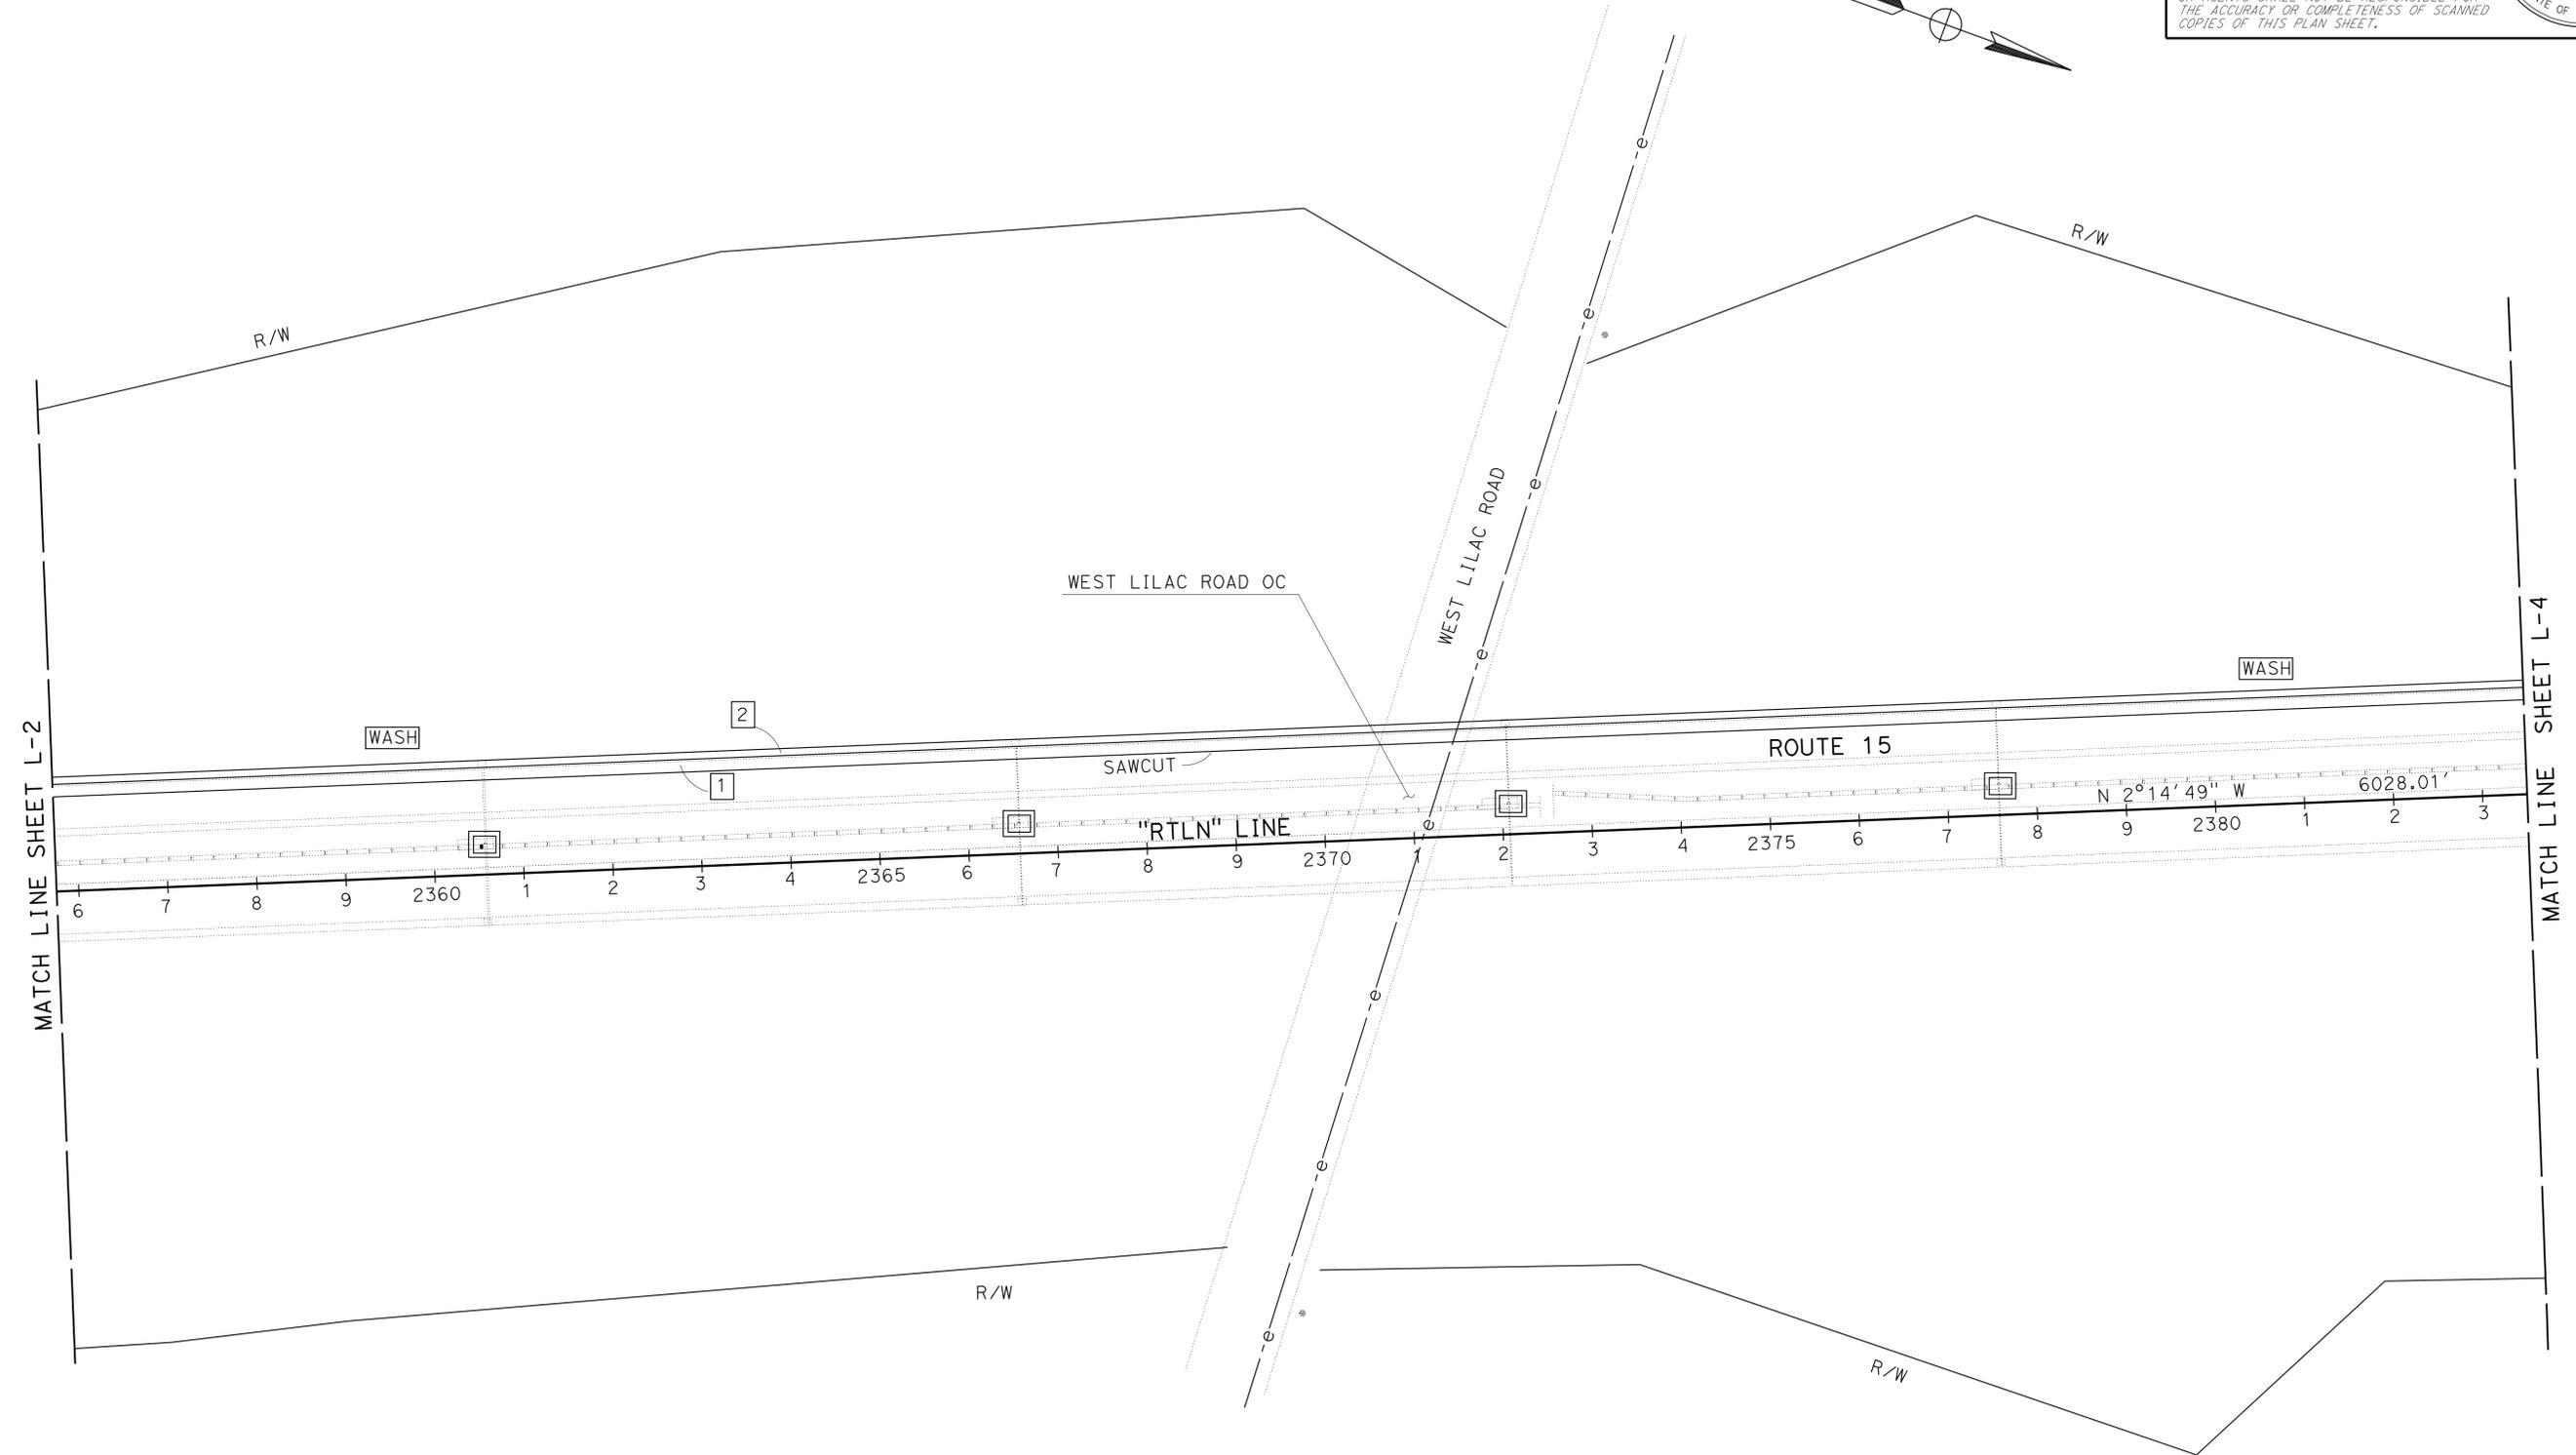
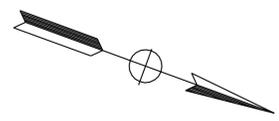
  

REGISTERED PROFESSIONAL ENGINEER
SHAHRIAR SOROURBAKSH
No. 52814
Exp. 12-31-11
CIVIL
STATE OF CALIFORNIA

THE STATE OF CALIFORNIA OR ITS OFFICERS OR AGENTS SHALL NOT BE RESPONSIBLE FOR THE ACCURACY OR COMPLETENESS OF SCANNED COPIES OF THIS PLAN SHEET.

**NOTE :**

1. FOR ACCURATE RIGHT OF WAY CONTACT RIGHT OF WAY ENGINEERING AT THE DISTRICT OFFICE.



STATE OF CALIFORNIA - DEPARTMENT OF TRANSPORTATION  
**Caltrans**  
**DESIGN**  
 FUNCTIONAL SUPERVISOR: CHRIS M THOMAS  
 CALCULATED/DESIGNED BY: GARRY WILLIAMS  
 REVISIONS: SHAHRIAR SOROURBAKSH  
 REVISIONS: GARRY WILLIAMS

**LAYOUT**

SCALE: 1"=100' **L-3**

LAST REVISION | DATE PLOTTED => 01-NOV-2010  
 10-28-10 TIME PLOTTED => 14:53

Dist	COUNTY	ROUTE	POST MILES TOTAL PROJECT	SHEET No.	TOTAL SHEETS
11	SD	15	R42.5/R45.9	7	46

08-01-10  
 REGISTERED CIVIL ENGINEER DATE  
 10-04-10  
 PLANS APPROVAL DATE

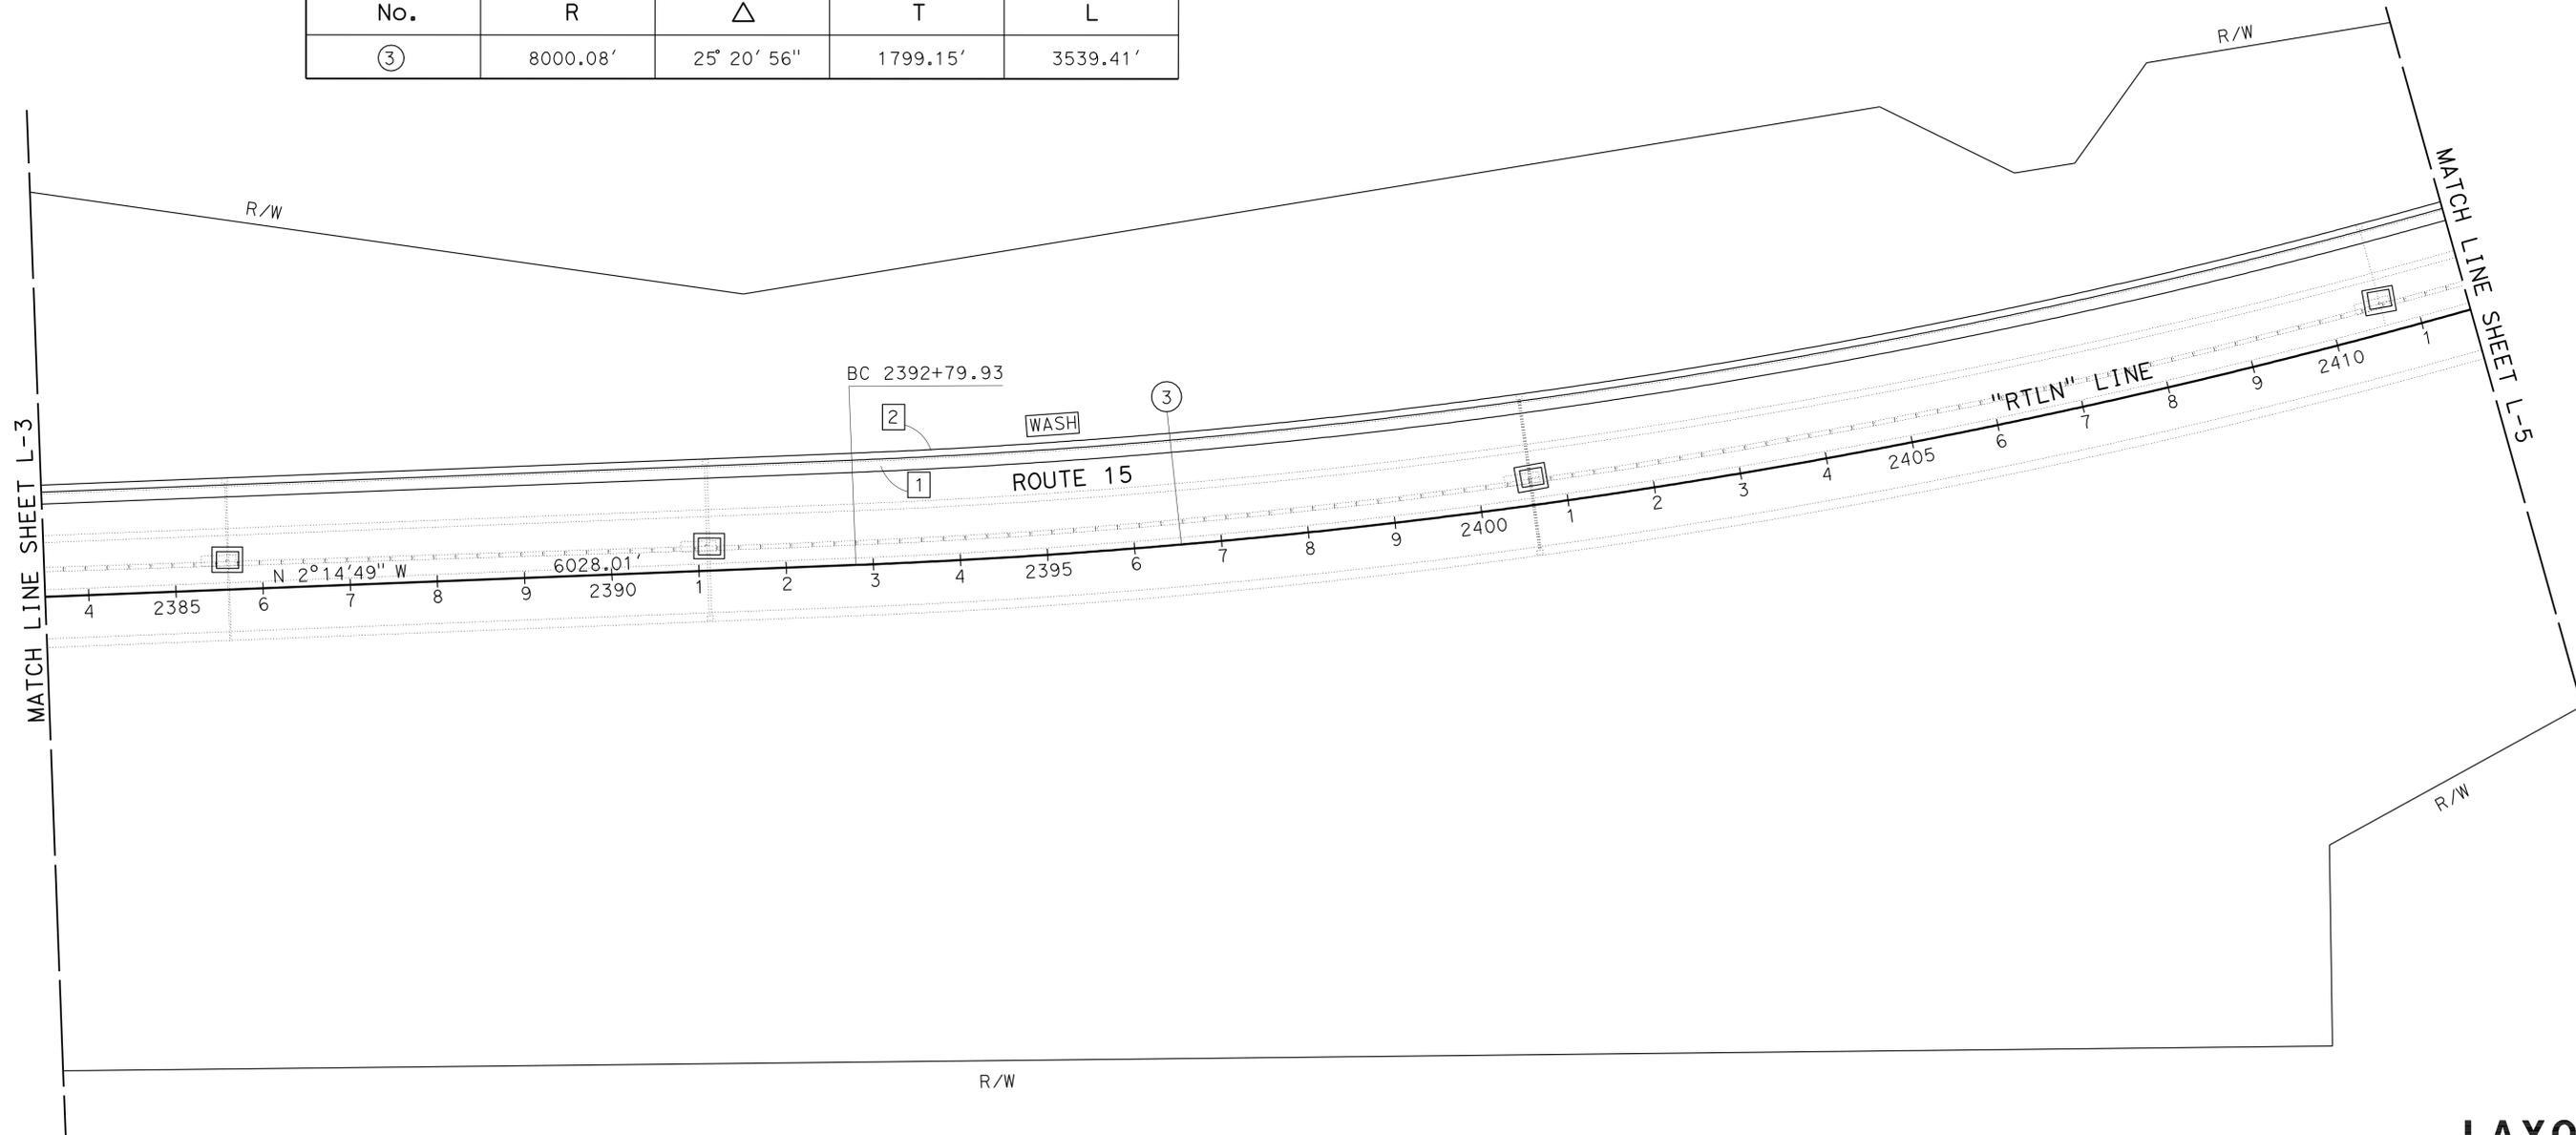
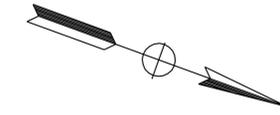
REGISTERED PROFESSIONAL ENGINEER  
 SHAHRIAR SOROURBAKHS  
 No. 52814  
 Exp. 12-31-11  
 CIVIL  
 STATE OF CALIFORNIA

THE STATE OF CALIFORNIA OR ITS OFFICERS  
 OR AGENTS SHALL NOT BE RESPONSIBLE FOR  
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 COPIES OF THIS PLAN SHEET.

**NOTE:**

1. FOR ACCURATE RIGHT OF WAY CONTACT RIGHT OF WAY ENGINEERING AT THE DISTRICT OFFICE.

CURVE DATA				
No.	R	$\Delta$	T	L
③	8000.08'	25° 20' 56"	1799.15'	3539.41'



STATE OF CALIFORNIA - DEPARTMENT OF TRANSPORTATION  
**Caltrans**  
 DESIGN  
 FUNCTIONAL SUPERVISOR  
 CHRIS M THOMAS  
 CALCULATED/DESIGNED BY  
 CHECKED BY  
 SHAHRIAR SOROURBAKHS  
 GARRY WILLIAMS  
 REVISED BY  
 DATE REVISED

**LAYOUT**

SCALE: 1"=100' **L-4**

LAST REVISION | DATE PLOTTED => 01-NOV-2010  
 10-28-10 TIME PLOTTED => 14:33

Dist	COUNTY	ROUTE	POST MILES TOTAL PROJECT	SHEET No.	TOTAL SHEETS
11	SD	15	R42.5/R45.9	8	46

08-01-10  
 REGISTERED CIVIL ENGINEER DATE  
 10-04-10  
 PLANS APPROVAL DATE

REGISTERED PROFESSIONAL ENGINEER  
 SHAHRIAR SOROURBAKHS  
 No. 52814  
 Exp. 12-31-11  
 CIVIL  
 STATE OF CALIFORNIA

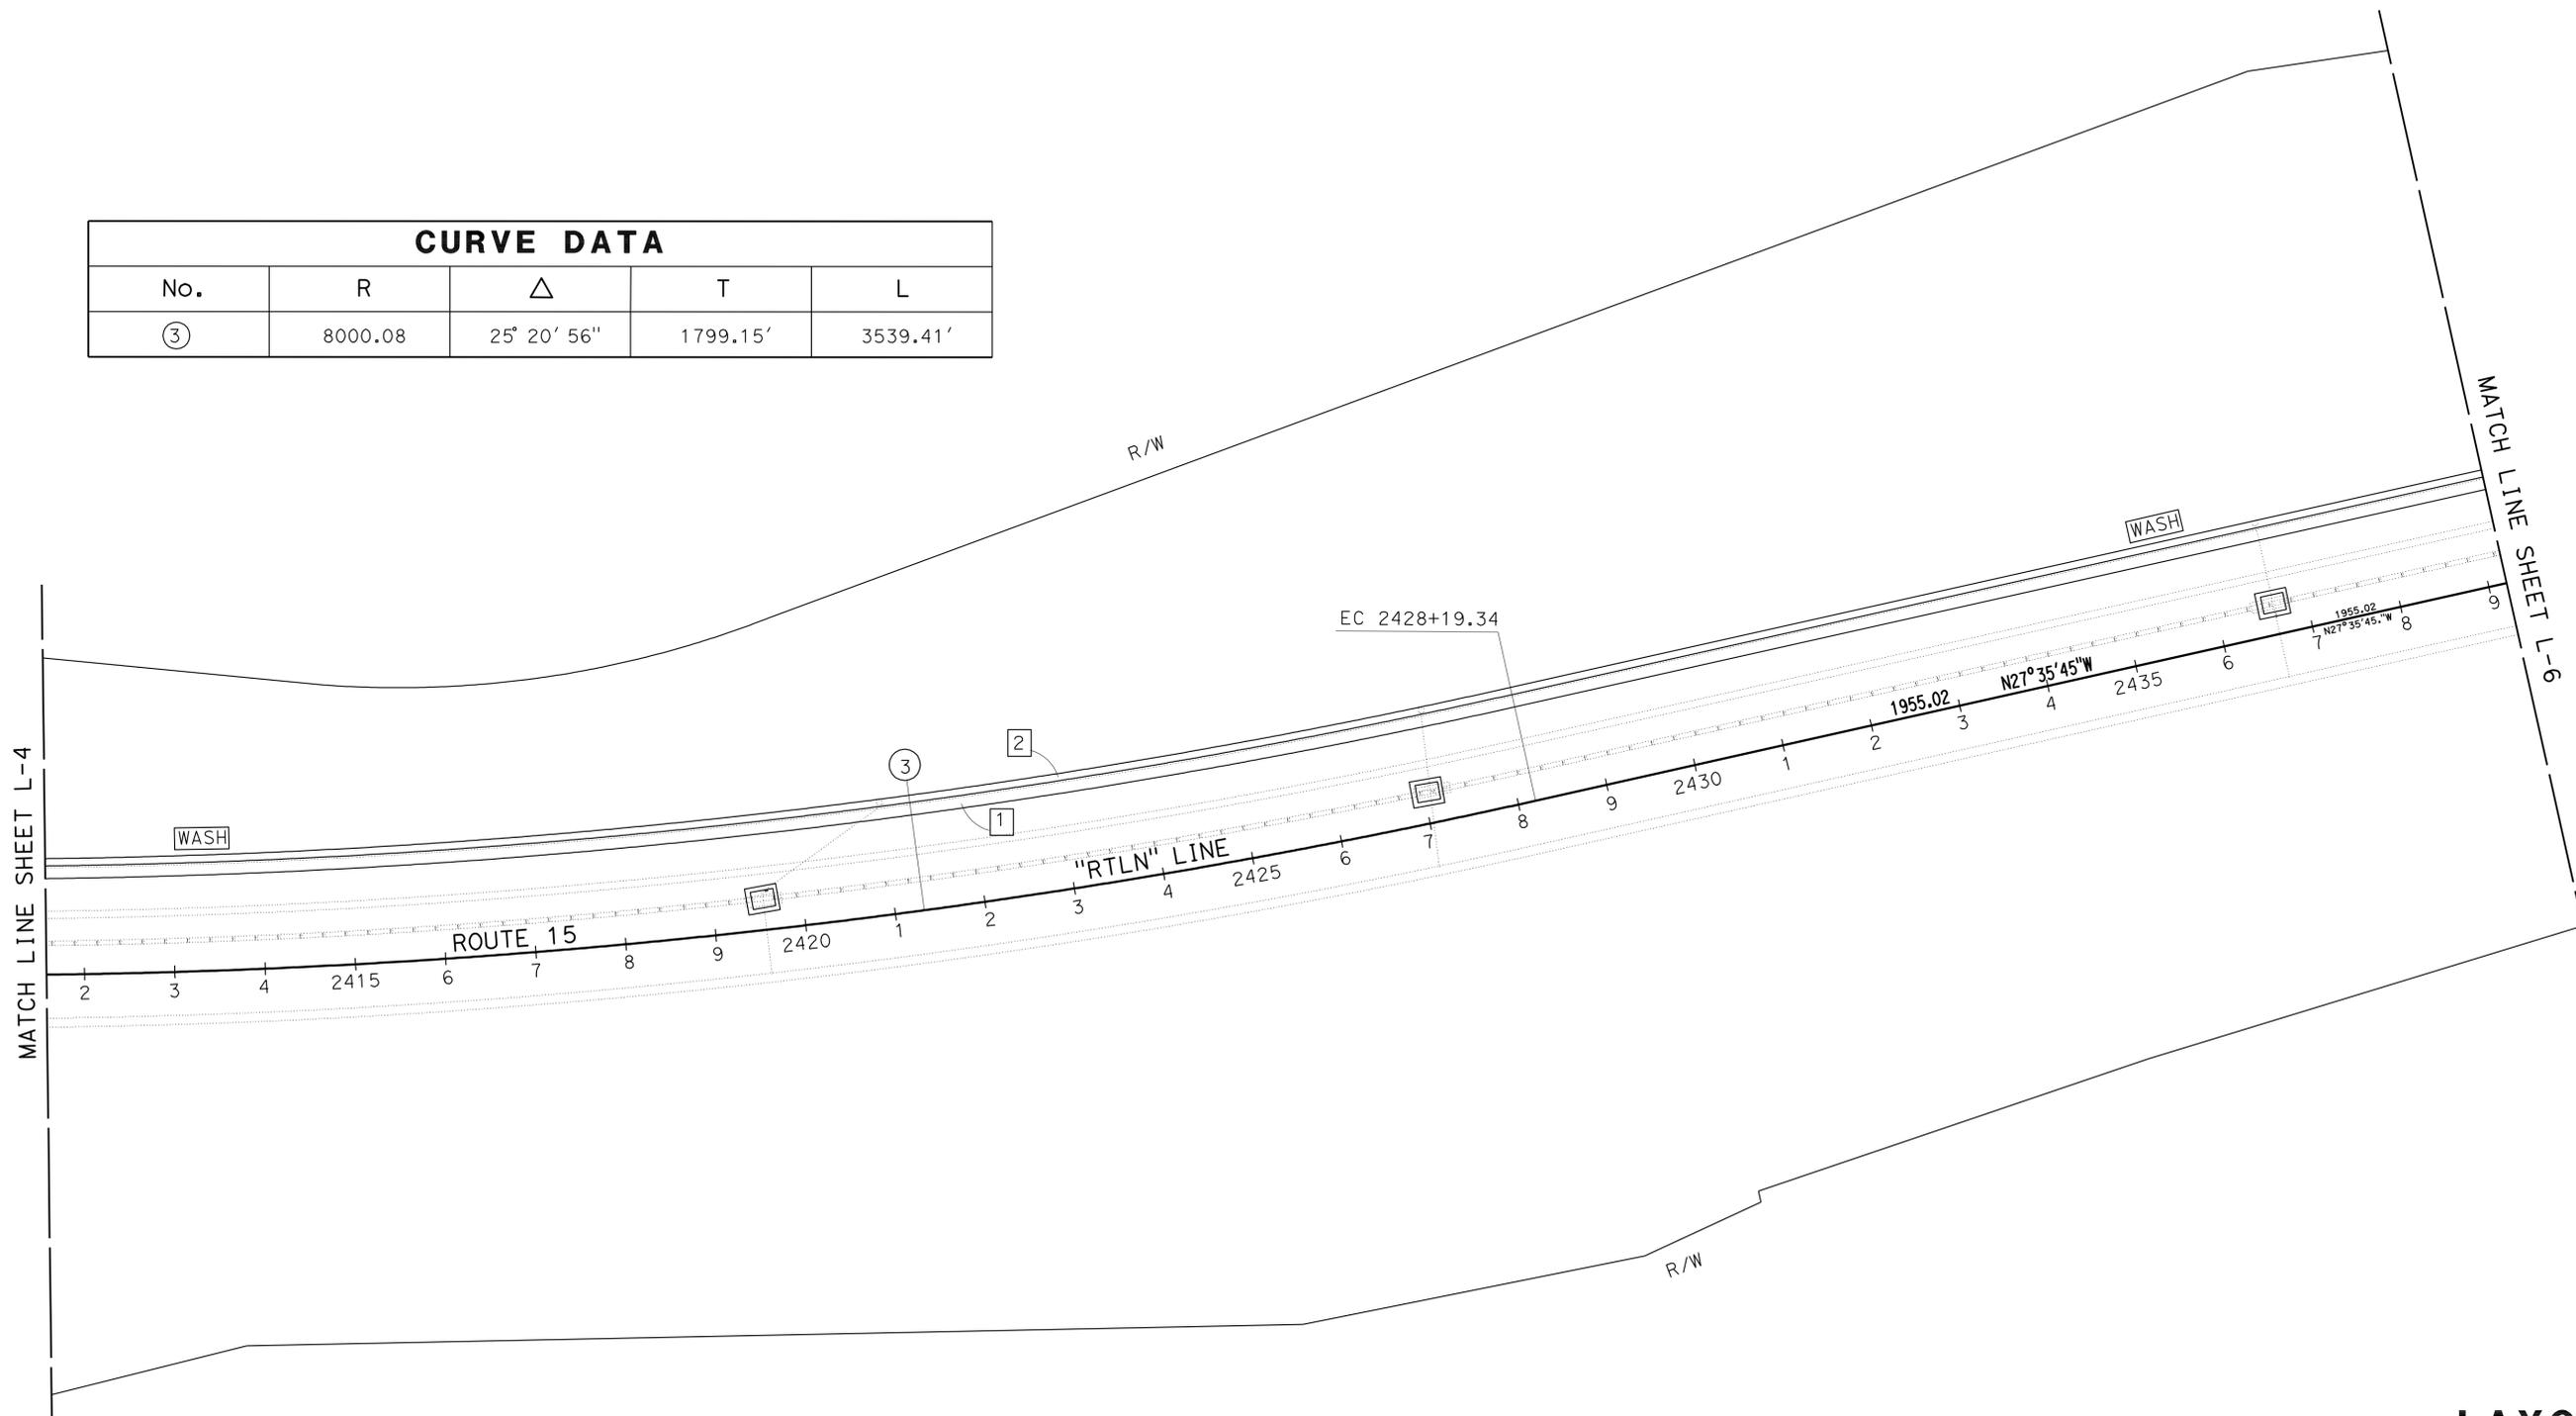
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**NOTE:**

1. FOR ACCURATE RIGHT OF WAY CONTACT RIGHT OF WAY ENGINEERING AT THE DISTRICT OFFICE.



CURVE DATA				
No.	R	Δ	T	L
③	8000.08	25° 20' 56"	1799.15'	3539.41'



STATE OF CALIFORNIA - DEPARTMENT OF TRANSPORTATION  
**Caltrans**  
 DESIGN  
 FUNCTIONAL SUPERVISOR  
 CHRIS M THOMAS  
 CALCULATED/DESIGNED BY  
 CHECKED BY  
 SHAHRIAR SOROURBAKHS  
 GARRY WILLIAMS  
 REVISED BY  
 DATE REVISED

**LAYOUT**  
**L-5**



SCALE: 1"=100'



**NOTE:**

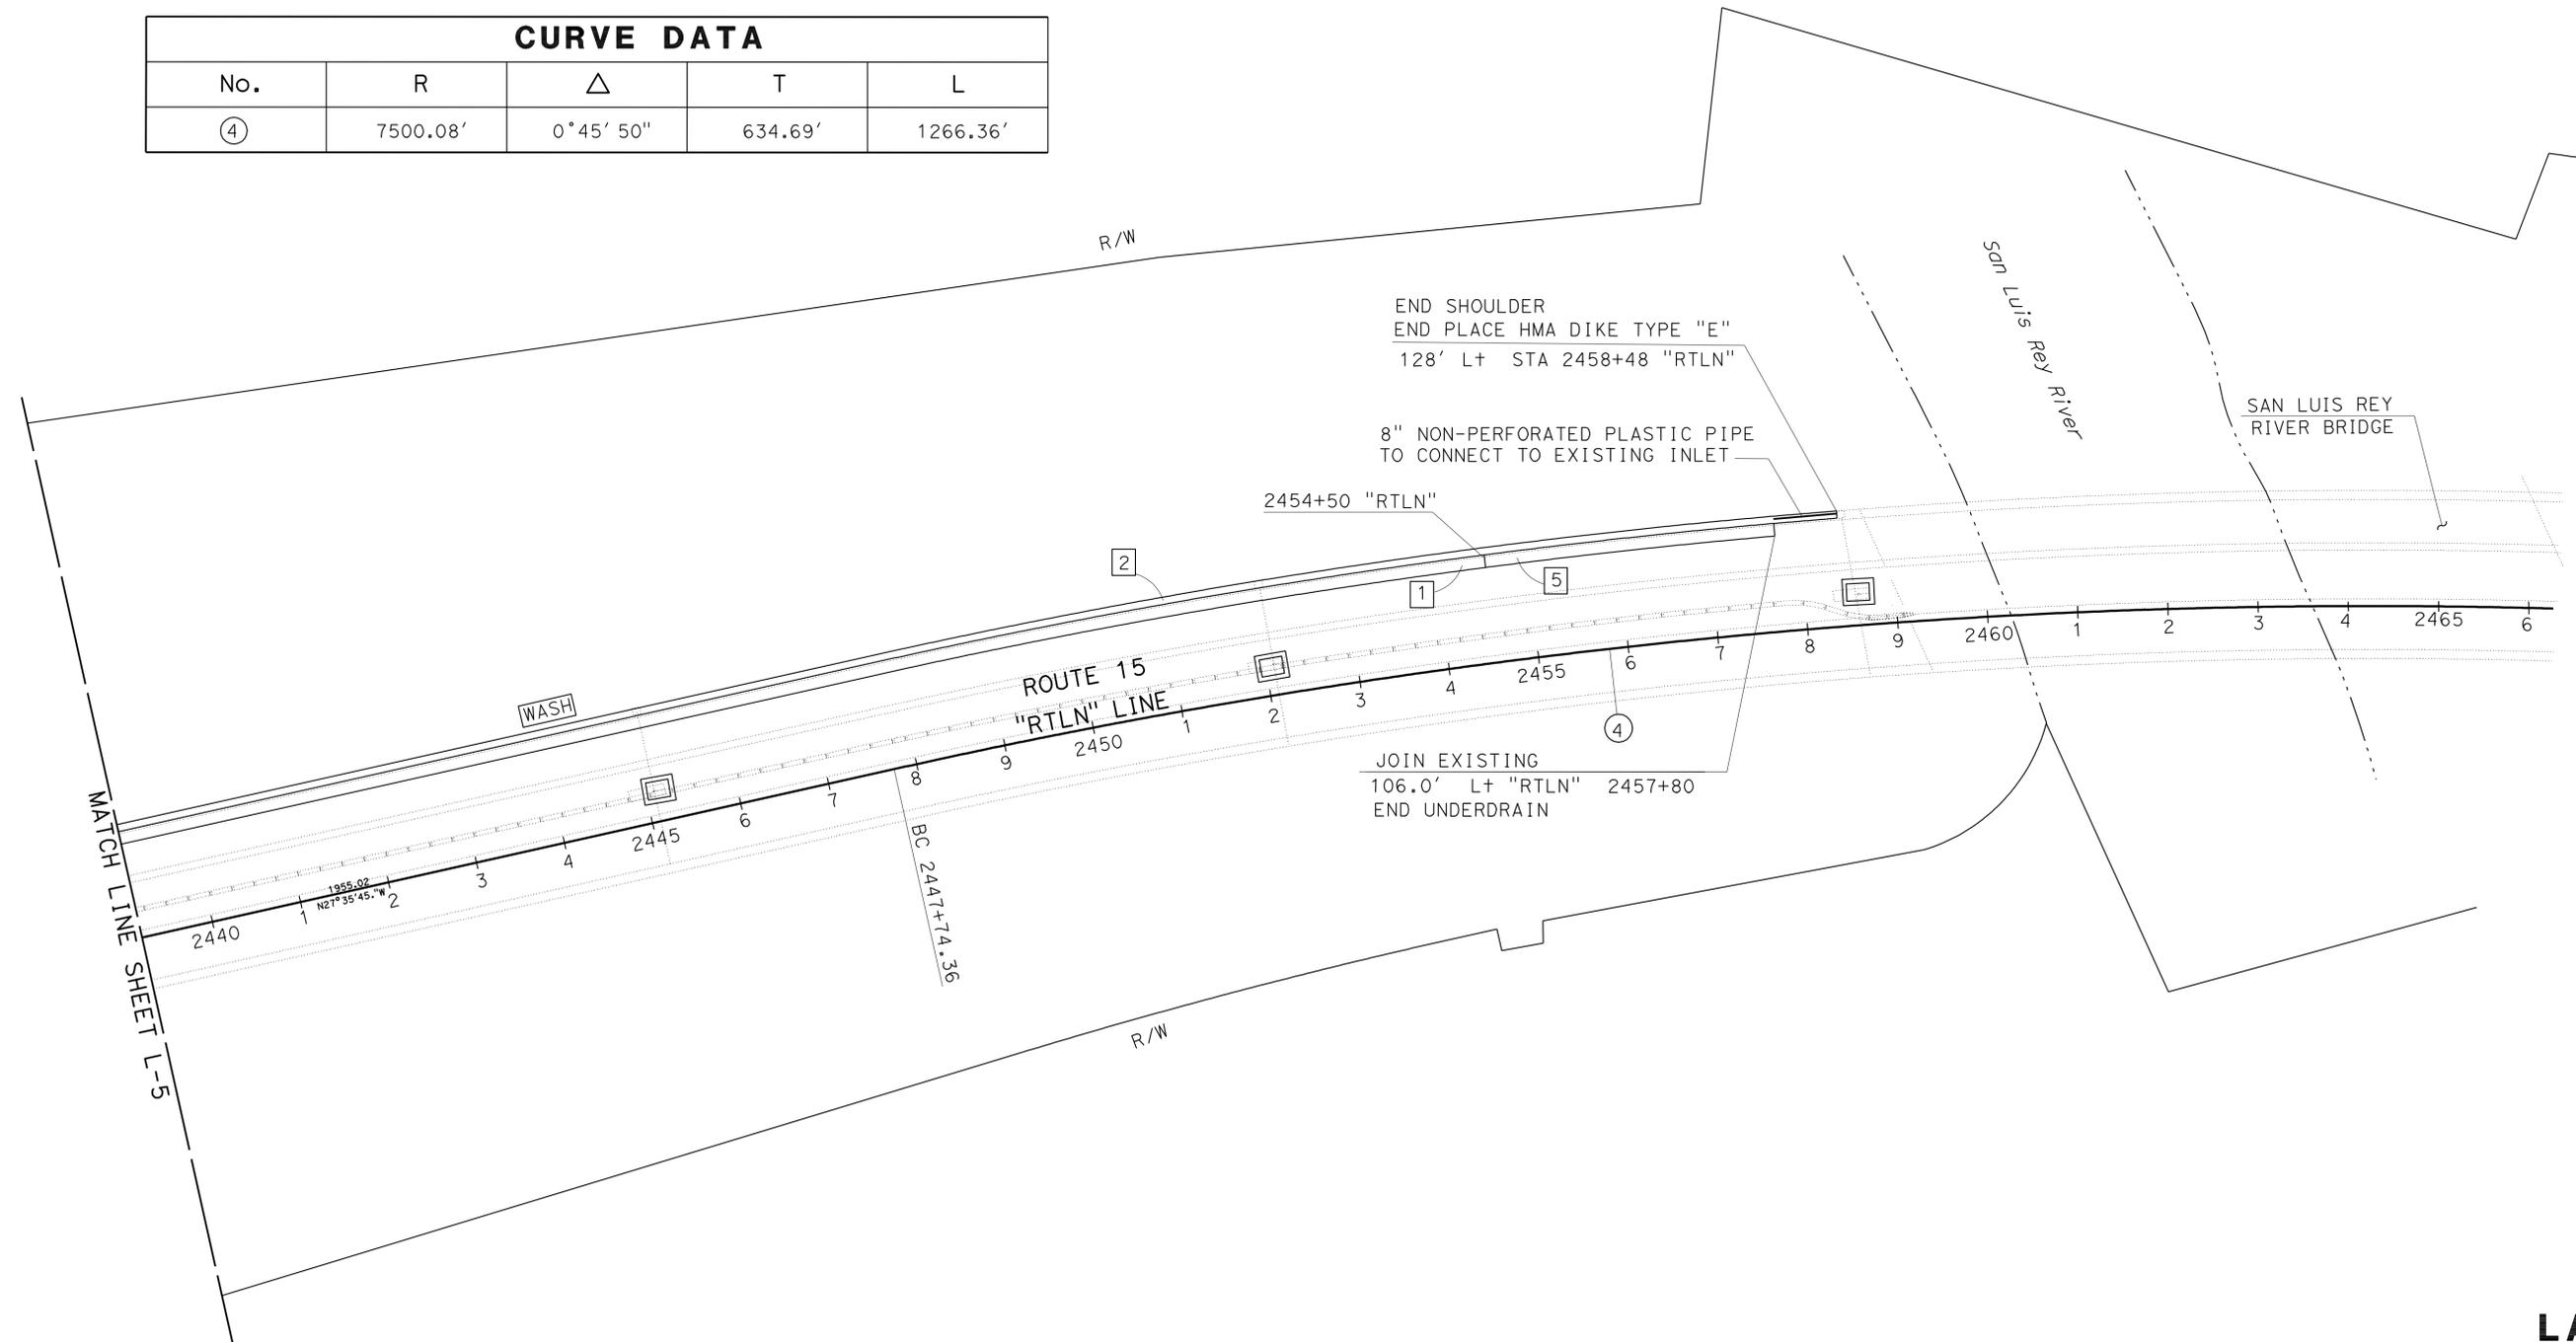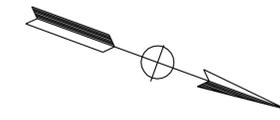1. FOR ACCURATE RIGHT OF WAY CONTACT RIGHT OF WAY ENGINEERING AT THE DISTRICT OFFICE.

CURVE DATA				
No.	R	$\Delta$	T	L
④	7500.08'	0°45'50"	634.69'	1266.36'



STATE OF CALIFORNIA - DEPARTMENT OF TRANSPORTATION  
**Caltrans**  
 DESIGN  
 FUNCTIONAL SUPERVISOR: CHRIS M THOMAS  
 CALCULATED/DESIGNED BY: GARRY WILLIAMS  
 CHECKED BY: GARRY WILLIAMS  
 REVISED BY: GARRY WILLIAMS  
 DATE REVISED:

**LAYOUT**  
**L-6**

SCALE: 1"=100'

LAST REVISION DATE PLOTTED => 01-NOV-2010  
 10-28-10 TIME PLOTTED => 14:34

Dist	COUNTY	ROUTE	POST MILES TOTAL PROJECT	SHEET No.	TOTAL SHEETS
11	SD	15	R42.5/R45.9	10	46

08-01-10  
 REGISTERED CIVIL ENGINEER DATE  
 10-04-10  
 PLANS APPROVAL DATE







REGISTERED PROFESSIONAL ENGINEER  
 SHAHRIAR SOROUBAKHSH  
 No. 52814  
 Exp. 12-31-11  
 CIVIL  
 STATE OF CALIFORNIA

THE STATE OF CALIFORNIA OR ITS OFFICERS OR AGENTS SHALL NOT BE RESPONSIBLE FOR THE ACCURACY OR COMPLETENESS OF SCANNED COPIES OF THIS PLAN SHEET.

**LEGEND:**

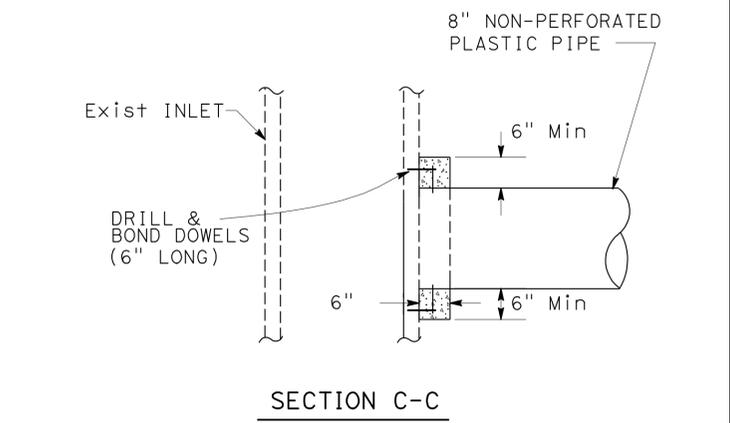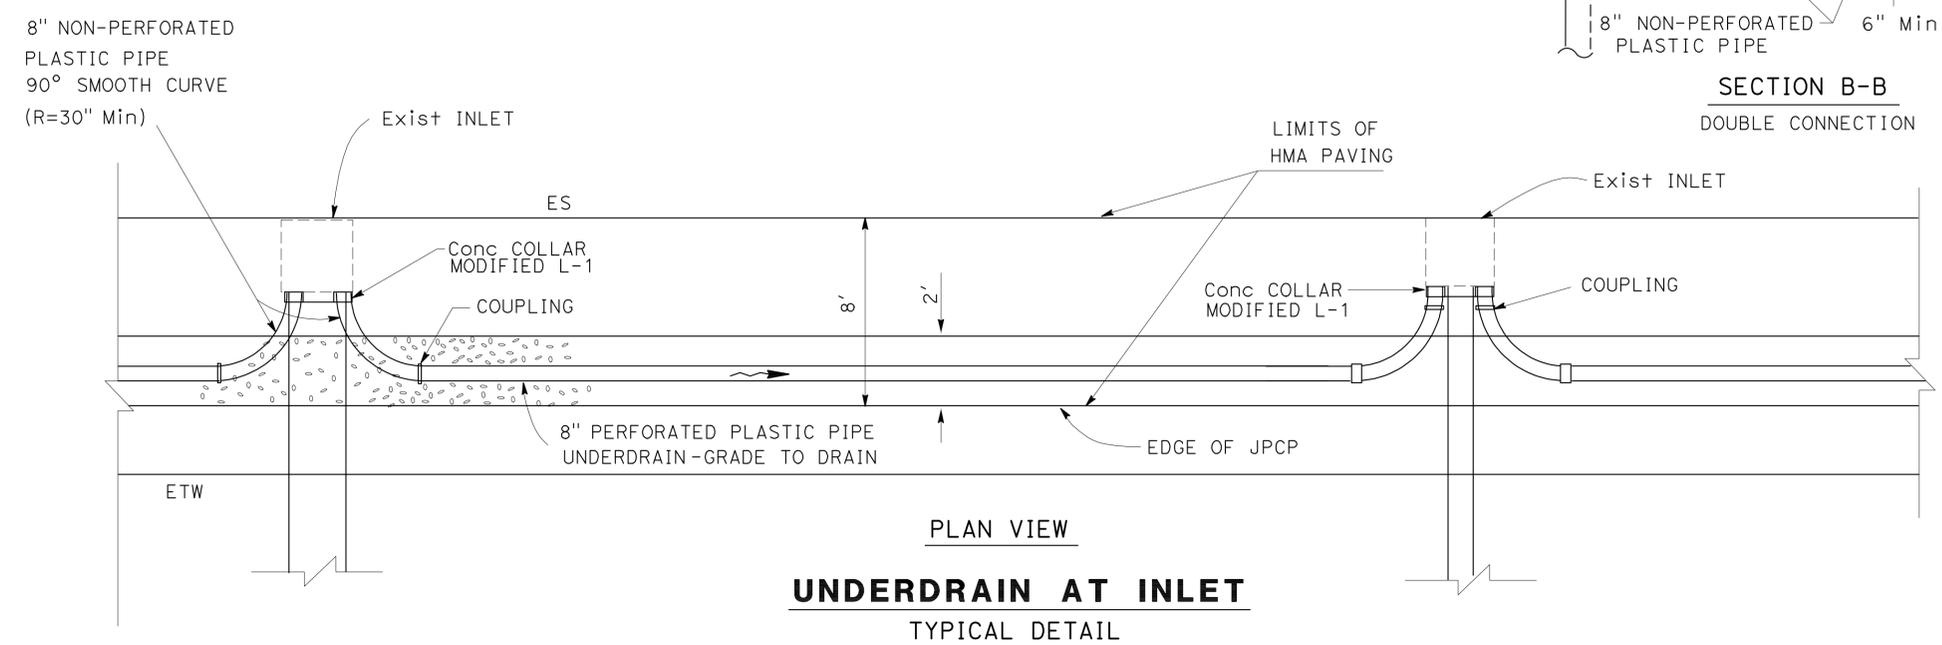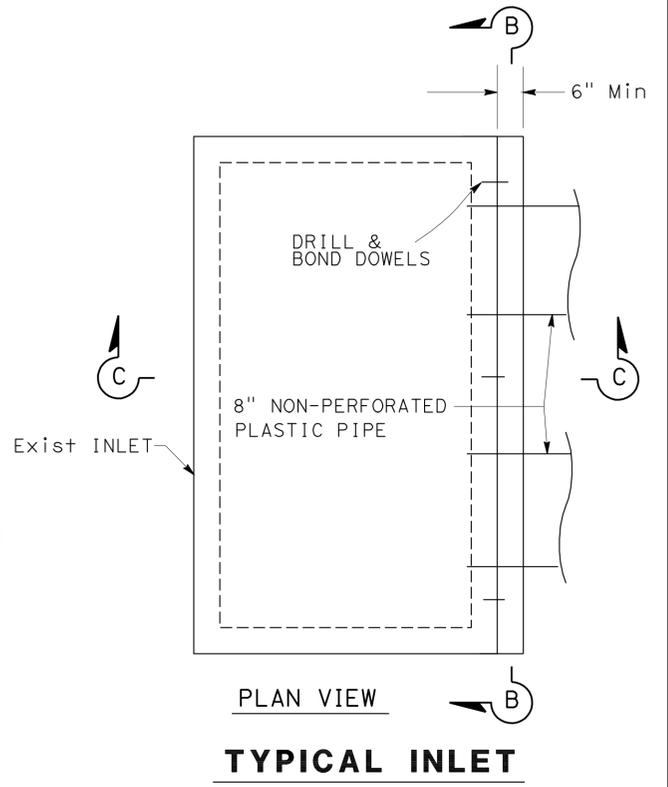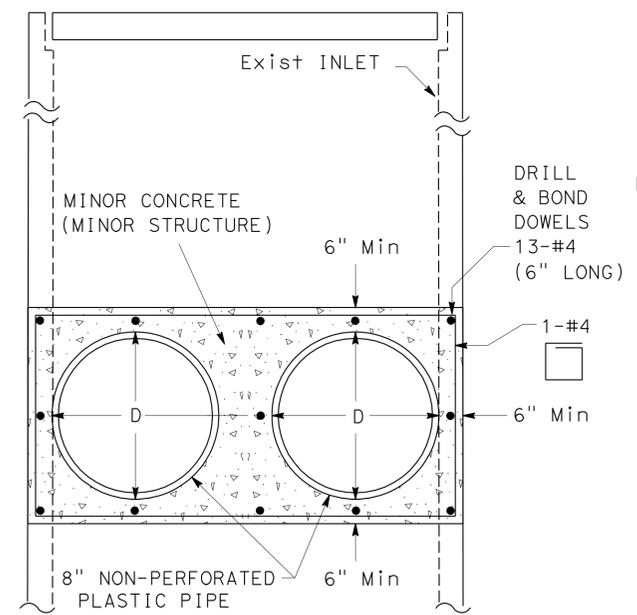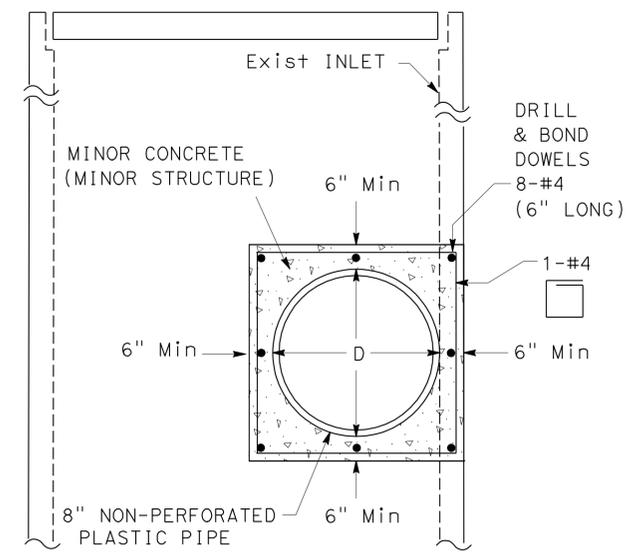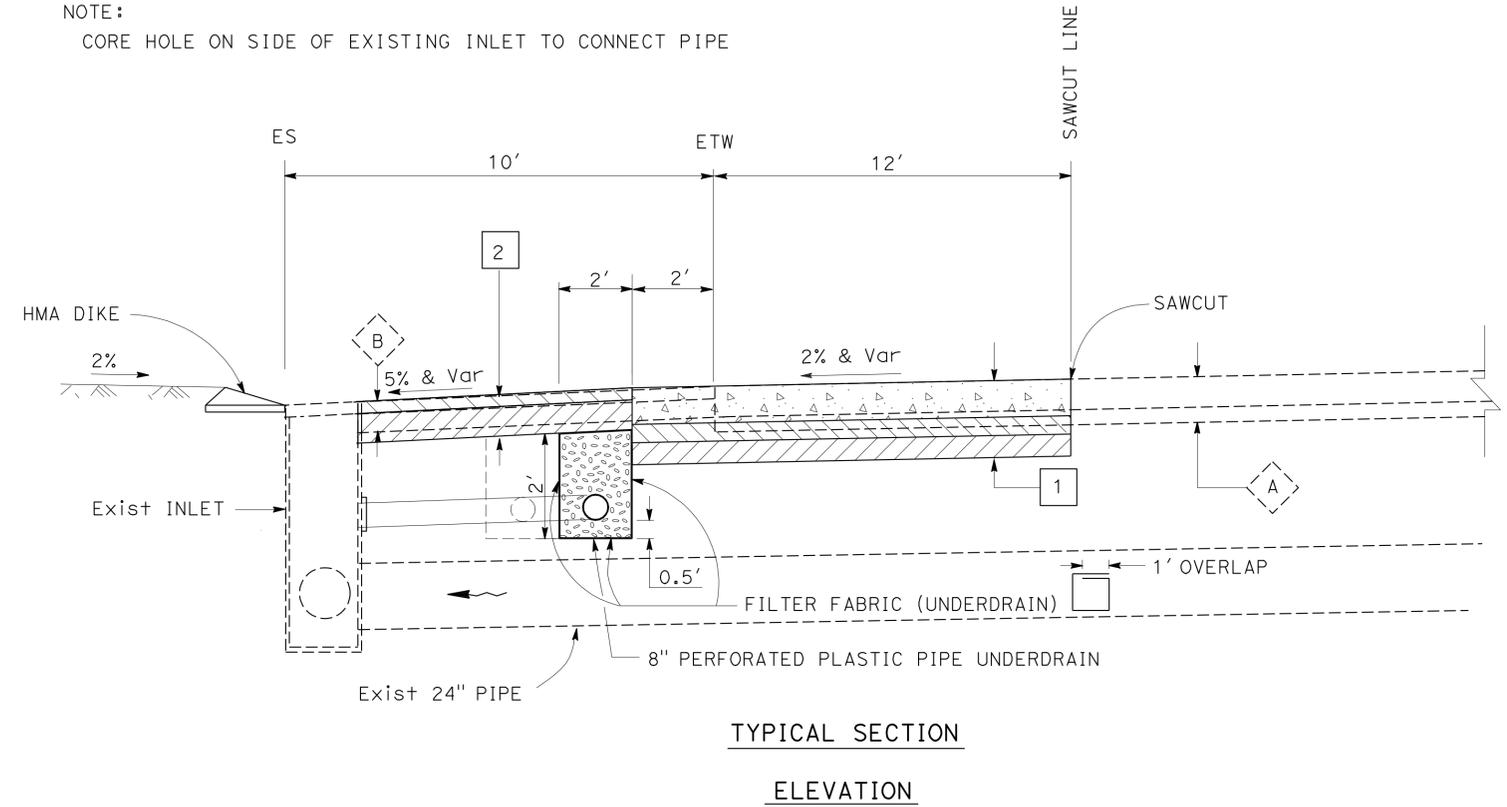-  JPCP
-  HMA-A
-  AB-CLASS 2
-  PERMEABLE MATERIAL
-  DIRECTION OF FLOW
-  1  
1.00' JPCP  
0.50' HMA-A  
0.65' AB-CLASS 2
-  2  
0.35' HMA-A  
0.95' AB-CLASS 2
-  Exist  
0.80' PCC  
0.45' CTB
-  Exist  
0.35' AC  
0.45' AB


NOTE:  
CORE HOLE ON SIDE OF EXISTING INLET TO CONNECT PIPE



**CONSTRUCTION DETAILS C-1**  
NO SCALE

STATE OF CALIFORNIA - DEPARTMENT OF TRANSPORTATION  
 Shahriar Sorourbaksh  
 Garry Williams  
 Chris M Thomas  
 DESIGN

Dist	COUNTY	ROUTE	POST MILES TOTAL PROJECT	SHEET No.	TOTAL SHEETS
11	SD	15	R42.5/R45.9	11	46

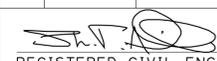 09-07-10  
 REGISTERED CIVIL ENGINEER DATE

10-04-10  
 PLANS APPROVAL DATE

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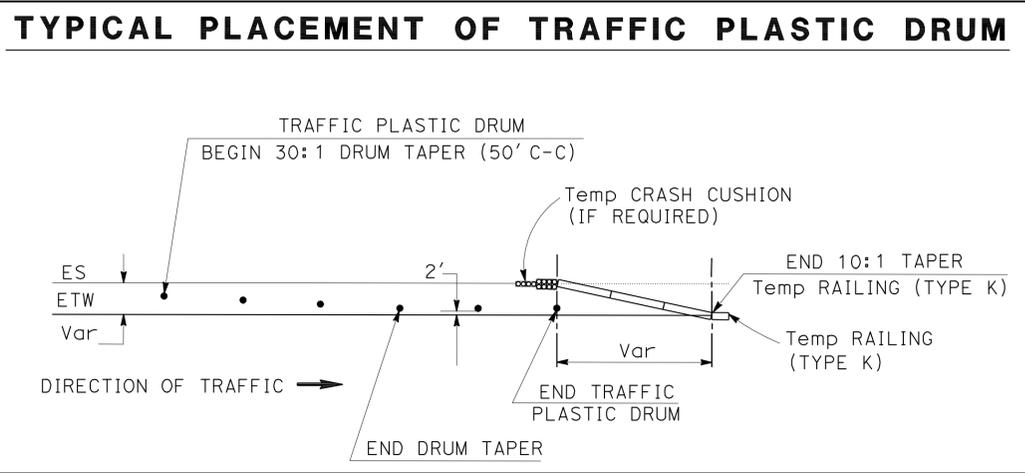
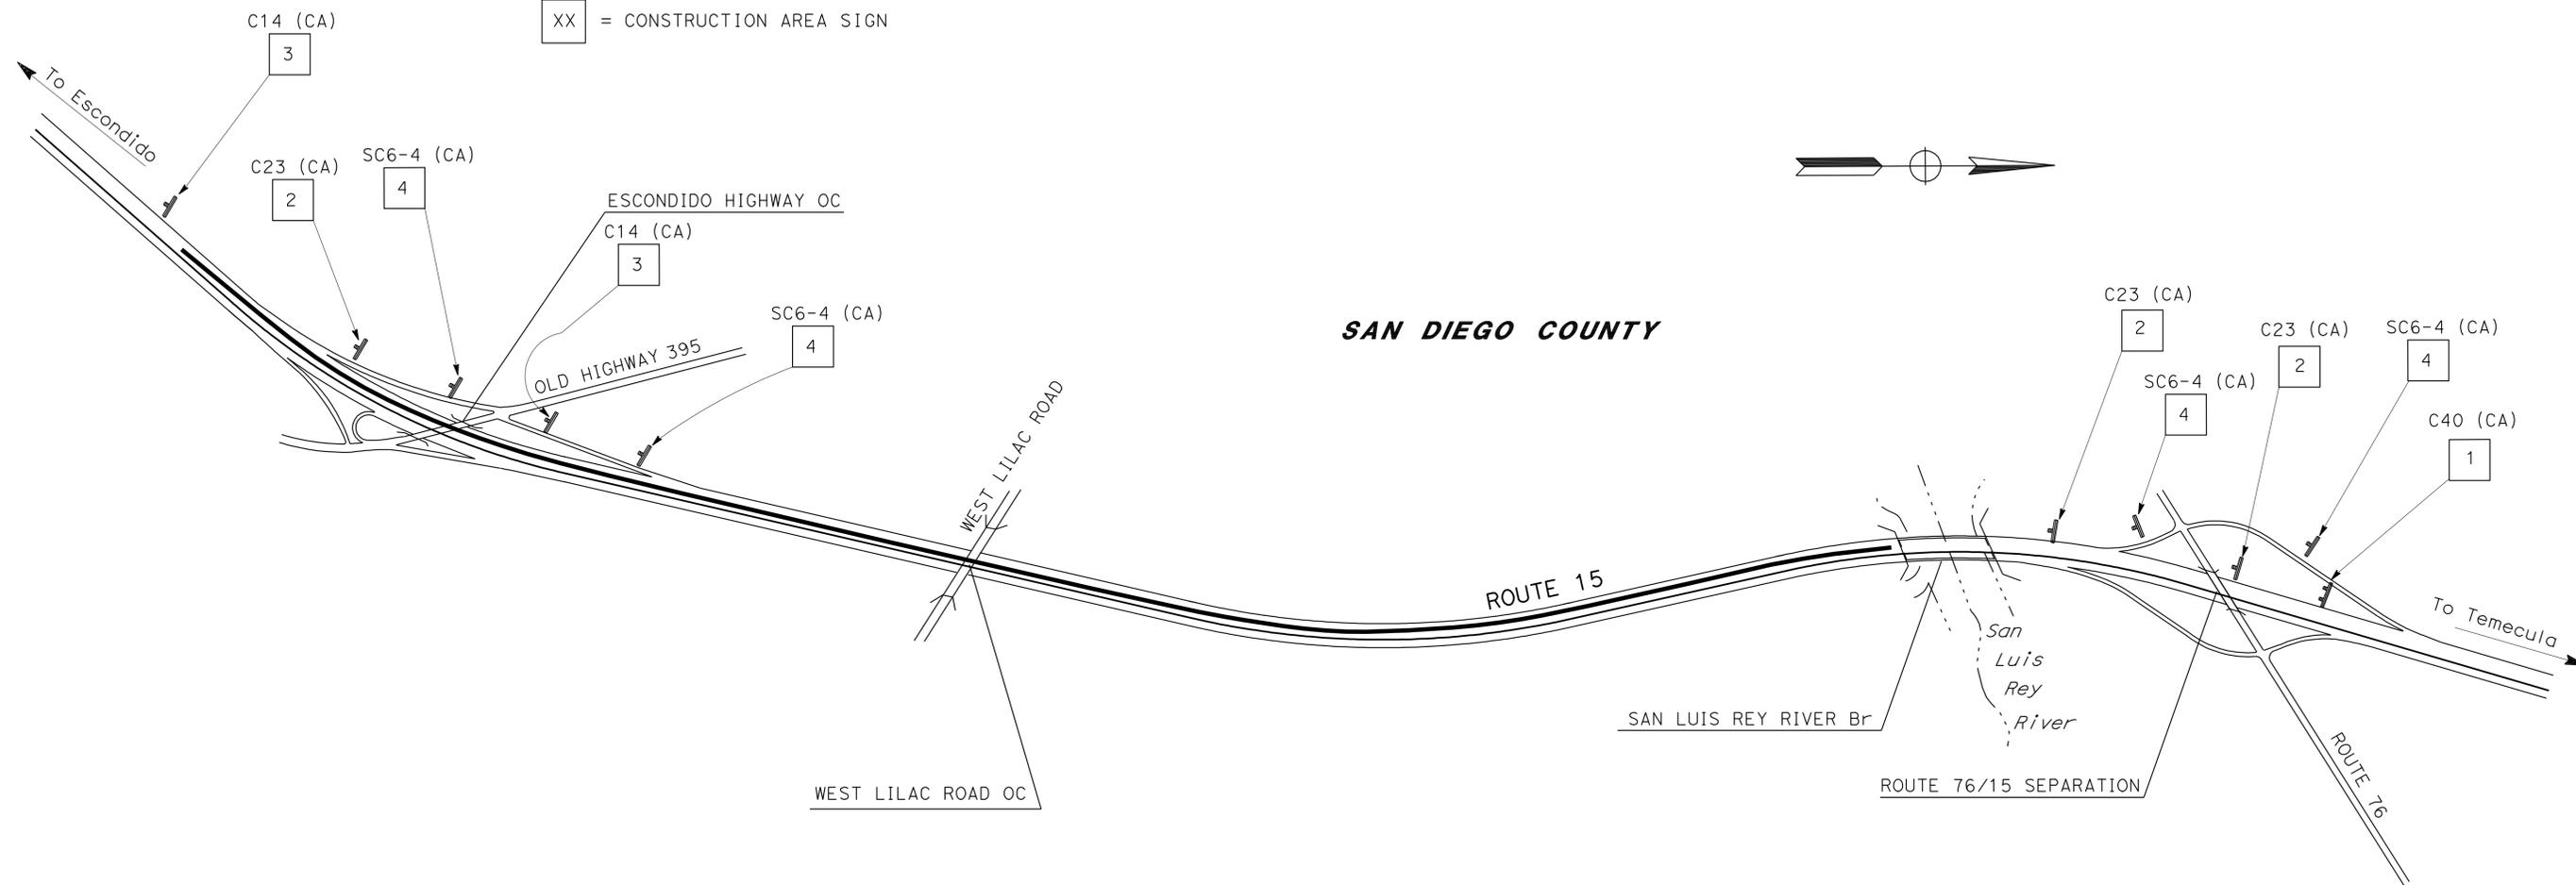
REGISTERED PROFESSIONAL ENGINEER  
 SHAHIN T. ADIBI  
 No. 54839  
 Exp. 06-30-12  
 CIVIL  
 STATE OF CALIFORNIA

**NOTES:**

1. EXACT LOCATION OF CONSTRUCTION AREA SIGNS WILL BE DETERMINED BY THE ENGINEER.
2. FEDERAL MANUAL ON UNIFORM TRAFFIC CONTROL DEVICES (MUTCD) SIGN CODES ARE SHOWN UNLESS DESIGNATED BY (CA), INDICATING CALIFORNIA MUTCD.
3. SEE TRAFFIC HANDLING AND STAGE CONSTRUCTION PLANS FOR ADDITIONAL CONSTRUCTION AREA SIGNS.
4. EXISTING UTILITIES ARE NOT SHOWN ON THIS PLAN SHEET. THE CONTRACTOR SHALL VERIFY LOCATIONS OF EXISTING UTILITIES AND ADJUST THE FIELD LOCATION OF SIGN POSTS IN CONSULTATION WITH THE ENGINEER.

**LEGEND**

XX = CONSTRUCTION AREA SIGN



CONSTRUCTION AREA SIGNS				
SIGN No.	CODE	PANEL SIZE (In)	No. OF POST AND SIZE (In)	No. OF SIGNS
1	C40 (CA)	108 X 42	2-4 X 6 (S)	1
2	C23 (CA)	48 X 48	1-4 X 6 (S)	3
3	C14 (CA)	48 X 24	1-4 X 4 (S)	2
4	SC6-4 (CA)	48 X 60	PORTABLE	4
<b>TOTAL</b>				<b>10</b>

(S) DENOTES STATIONARY MOUNTED SIGN

**CONSTRUCTION AREA SIGNS**

NO SCALE

**CS-1**

THIS PLAN ACCURATE FOR CONSTRUCTION AREA SIGN WORK ONLY.

STATE OF CALIFORNIA - DEPARTMENT OF TRANSPORTATION  
**Caltrans** TRAFFIC DESIGN  
 FUNCTIONAL SUPERVISOR: CAMILLE ABOUFADEL  
 CHECKED BY: [Blank]  
 THANH NGUYEN  
 REVISIONS: [Blank]  
 REVISOR: [Blank] DATE: [Blank]

USERNAME => s127400  
 DGN FILE => b289701a001.dgn

RELATIVE BORDER SCALE IS IN INCHES  


UNIT 2763

PROJECT NUMBER & PHASE

11000200261

LAST REVISION: [Blank] DATE PLOTTED => 01-NOV-2010  
 09-29-10 TIME PLOTTED => 14:34

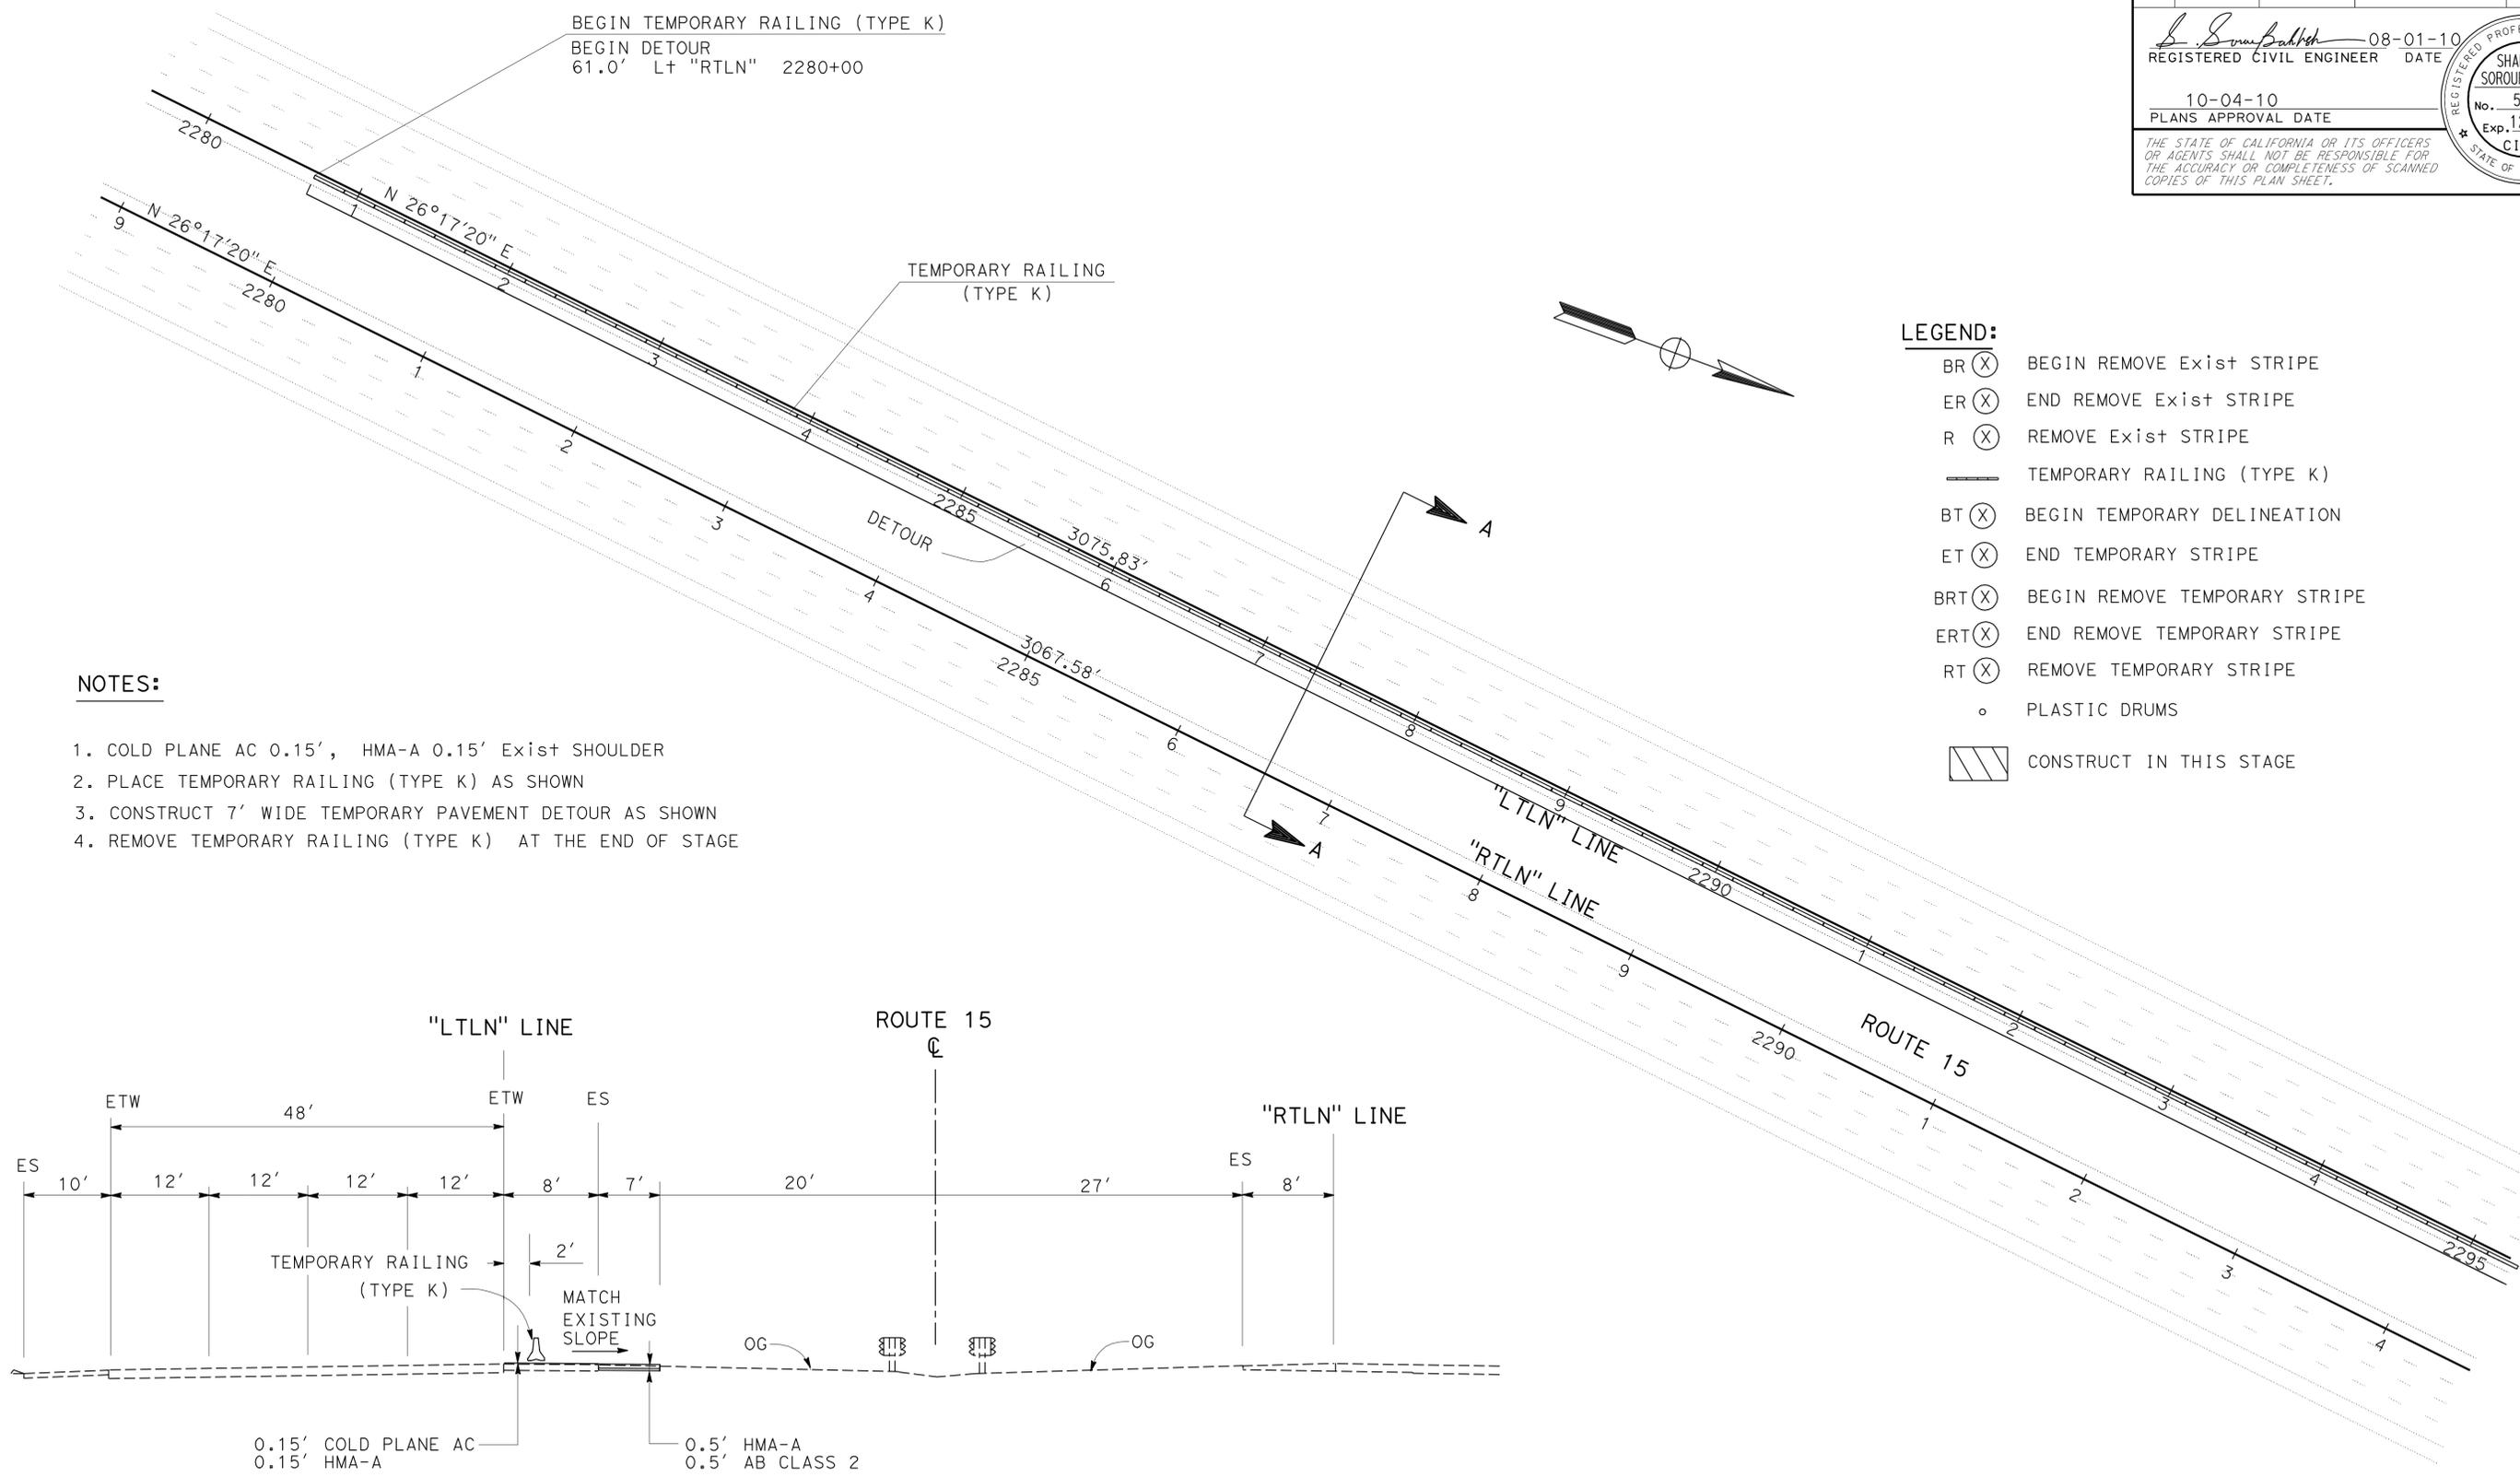
Dist	COUNTY	ROUTE	POST MILES TOTAL PROJECT	SHEET No.	TOTAL SHEETS
11	SD	15	R42.5/R45.9	12	46

08-01-10  
 REGISTERED CIVIL ENGINEER DATE  
 10-04-10  
 PLANS APPROVAL DATE

REGISTERED PROFESSIONAL ENGINEER  
 SHAHRIAR SOROURBAKSH  
 No. 52814  
 Exp. 12-31-11  
 CIVIL  
 STATE OF CALIFORNIA

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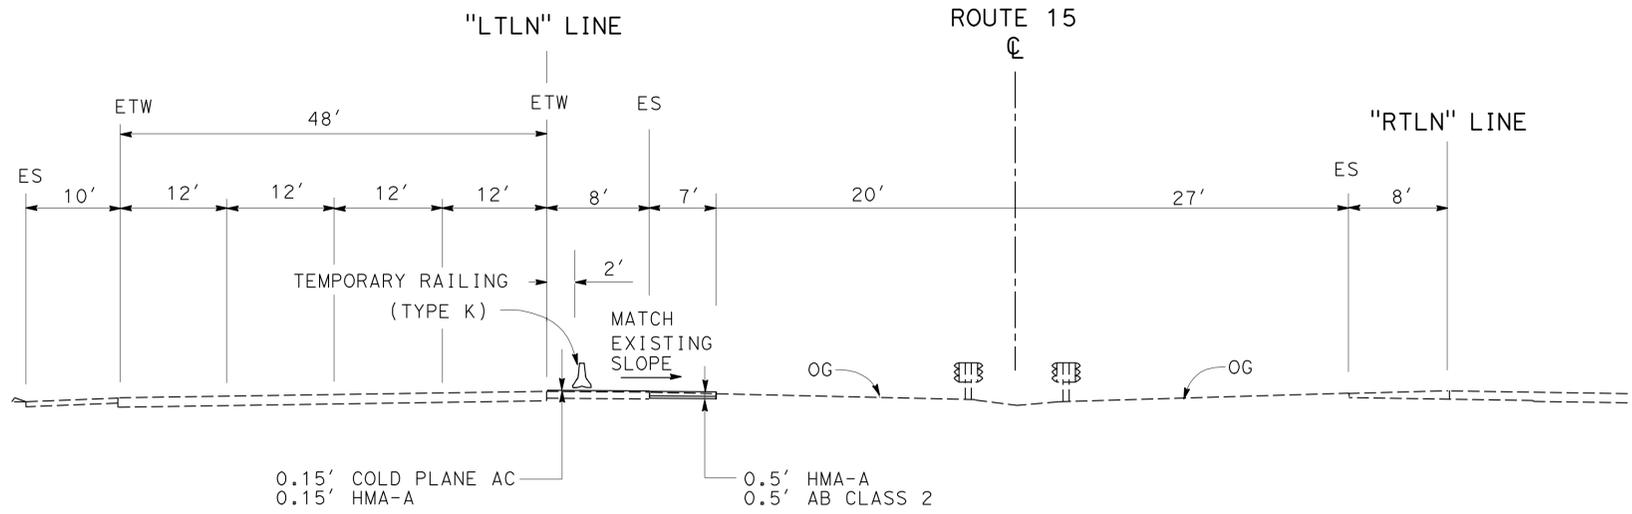
STATE OF CALIFORNIA - DEPARTMENT OF TRANSPORTATION  
**Caltrans**  
 DESIGN  
 FUNCTIONAL SUPERVISOR: CHRIS M THOMAS  
 CHECKED BY: GARRY WILLIAMS  
 CALCULATED/DESIGNED BY: SHAHRIAR SOROURBAKSH  
 REVISED BY: DATE REVISION:



- LEGEND:**
- BR (X) BEGIN REMOVE Exist STRIPE
  - ER (X) END REMOVE Exist STRIPE
  - R (X) REMOVE Exist STRIPE
  - TEMPORARY RAILING (TYPE K)
  - BT (X) BEGIN TEMPORARY DELINEATION
  - ET (X) END TEMPORARY STRIPE
  - BRT (X) BEGIN REMOVE TEMPORARY STRIPE
  - ERT (X) END REMOVE TEMPORARY STRIPE
  - RT (X) REMOVE TEMPORARY STRIPE
  - o PLASTIC DRUMS
  - ▨ CONSTRUCT IN THIS STAGE

**NOTES:**

1. COLD PLANE AC 0.15', HMA-A 0.15' Exist SHOULDER
2. PLACE TEMPORARY RAILING (TYPE K) AS SHOWN
3. CONSTRUCT 7' WIDE TEMPORARY PAVEMENT DETOUR AS SHOWN
4. REMOVE TEMPORARY RAILING (TYPE K) AT THE END OF STAGE



SECTION A-A  
STA 2280+00 TO STA 2457+80

**STAGE CONSTRUCTION  
STAGE 1**

SCALE: 1"=50'

**SC-1**

THIS PLAN ACCURATE FOR STAGE CONSTRUCTION WORK ONLY

LAST REVISION DATE PLOTTED => 01-NOV-2010  
 10-28-10 TIME PLOTTED => 14:34





STATE OF CALIFORNIA - DEPARTMENT OF TRANSPORTATION  
**Caltrans** DESIGN

FUNCTIONAL SUPERVISOR: CHRIS M THOMAS  
 CALCULATED/DESIGNED BY: [Blank]  
 CHECKED BY: [Blank]  
 SHAHRIAR SOROUBAKHSH  
 GARRY WILLIAMS  
 REVISED BY: [Blank] DATE REVISED: [Blank]

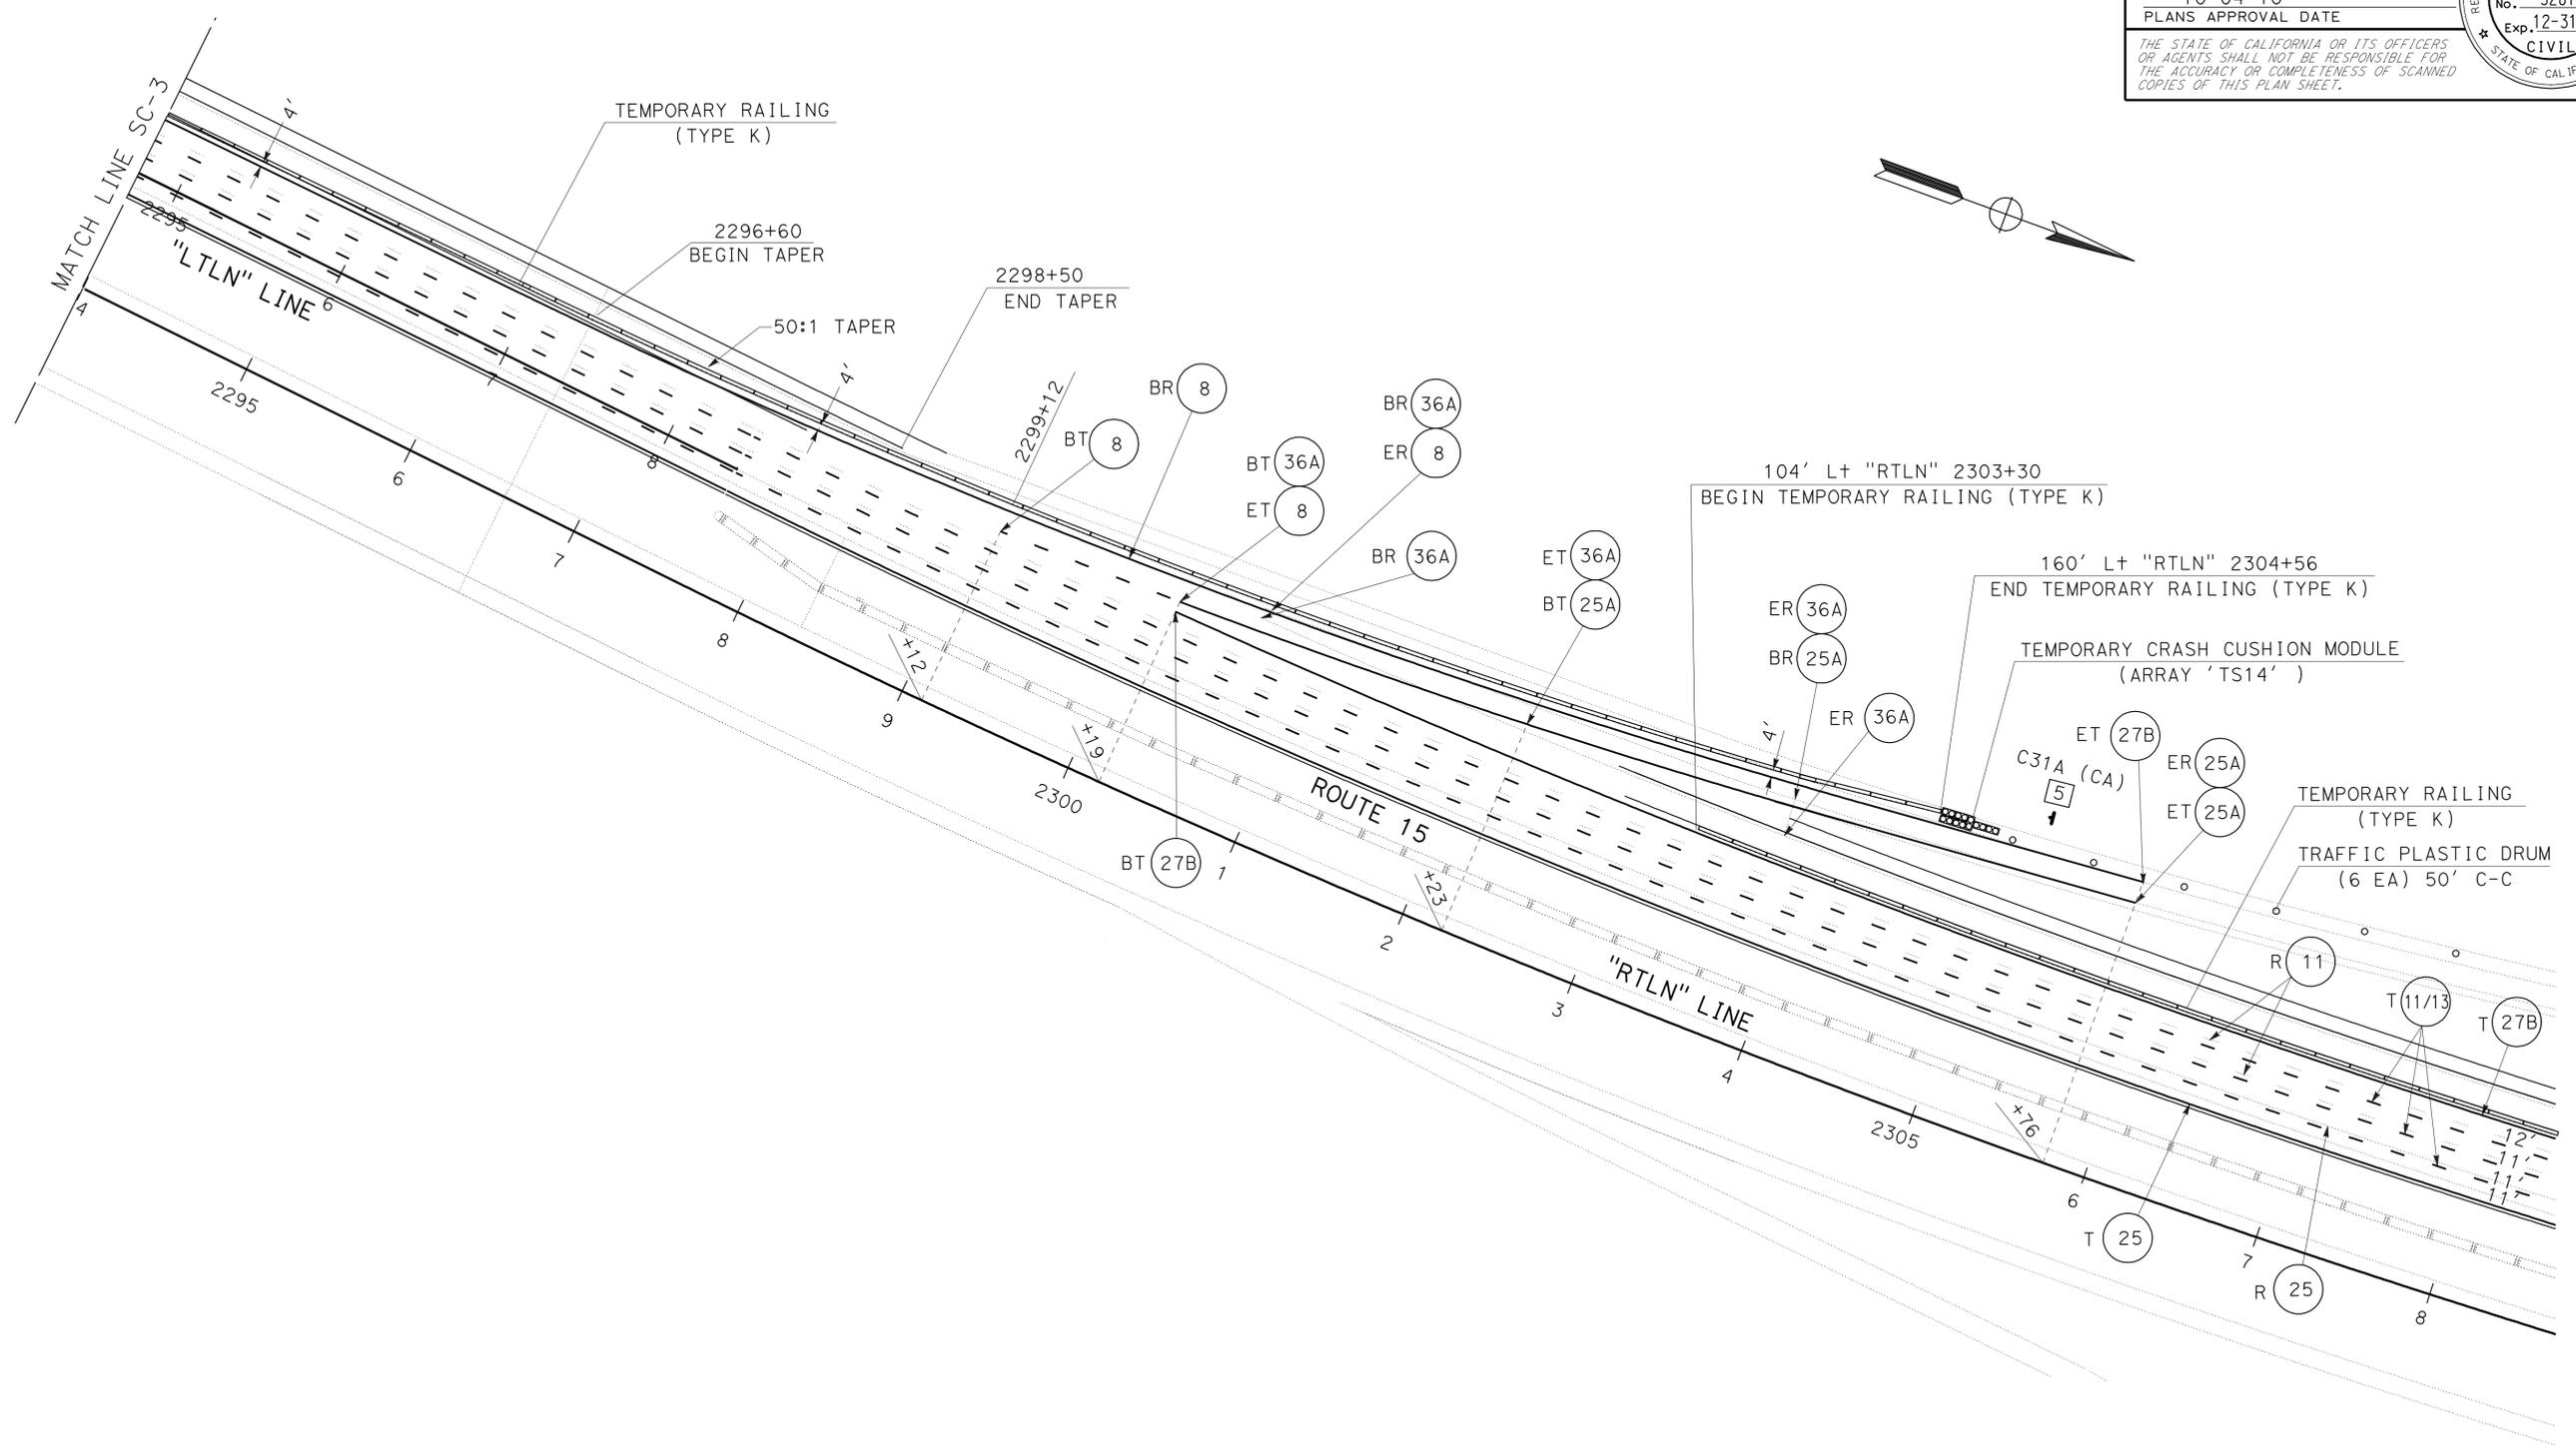
**NOTE:**  
 SEE CONSTRUCTION AREA SIGNS AND TRAFFIC HANDLING PLANS FOR ADDITIONAL CONSTRUCTION AREA SIGNS.

Dist	COUNTY	ROUTE	POST MILES TOTAL PROJECT	SHEET No.	TOTAL SHEETS
11	SD	15	R42.5/R45.9	15	46

REGISTERED CIVIL ENGINEER: *S. Soroubakhsh* 08-01-10  
 DATE: 10-04-10  
 PLANS APPROVAL DATE: 10-04-10

REGISTERED PROFESSIONAL ENGINEER: SHAHRIAR SOROUBAKHSH  
 No. 52814  
 Exp. 12-31-11  
 CIVIL

THE STATE OF CALIFORNIA OR ITS OFFICERS OR AGENTS SHALL NOT BE RESPONSIBLE FOR THE ACCURACY OR COMPLETENESS OF SCANNED COPIES OF THIS PLAN SHEET.



**STAGE CONSTRUCTION**  
**STAGE 2**  
 SCALE: 1"=50'  
**SC-4**

THIS PLAN ACCURATE FOR STAGE CONSTRUCTION WORK ONLY



LAST REVISION: 10-28-10 DATE PLOTTED => 01-NOV-2010 TIME PLOTTED => 14:34

Dist	COUNTY	ROUTE	POST MILES TOTAL PROJECT	SHEET No.	TOTAL SHEETS
11	SD	15	R42.5/R45.9	16	46

REGISTERED CIVIL ENGINEER DATE 08-01-10  
 No. 52814  
 Exp. 12-31-11  
 CIVIL  
 STATE OF CALIFORNIA

10-04-10  
 PLANS APPROVAL DATE

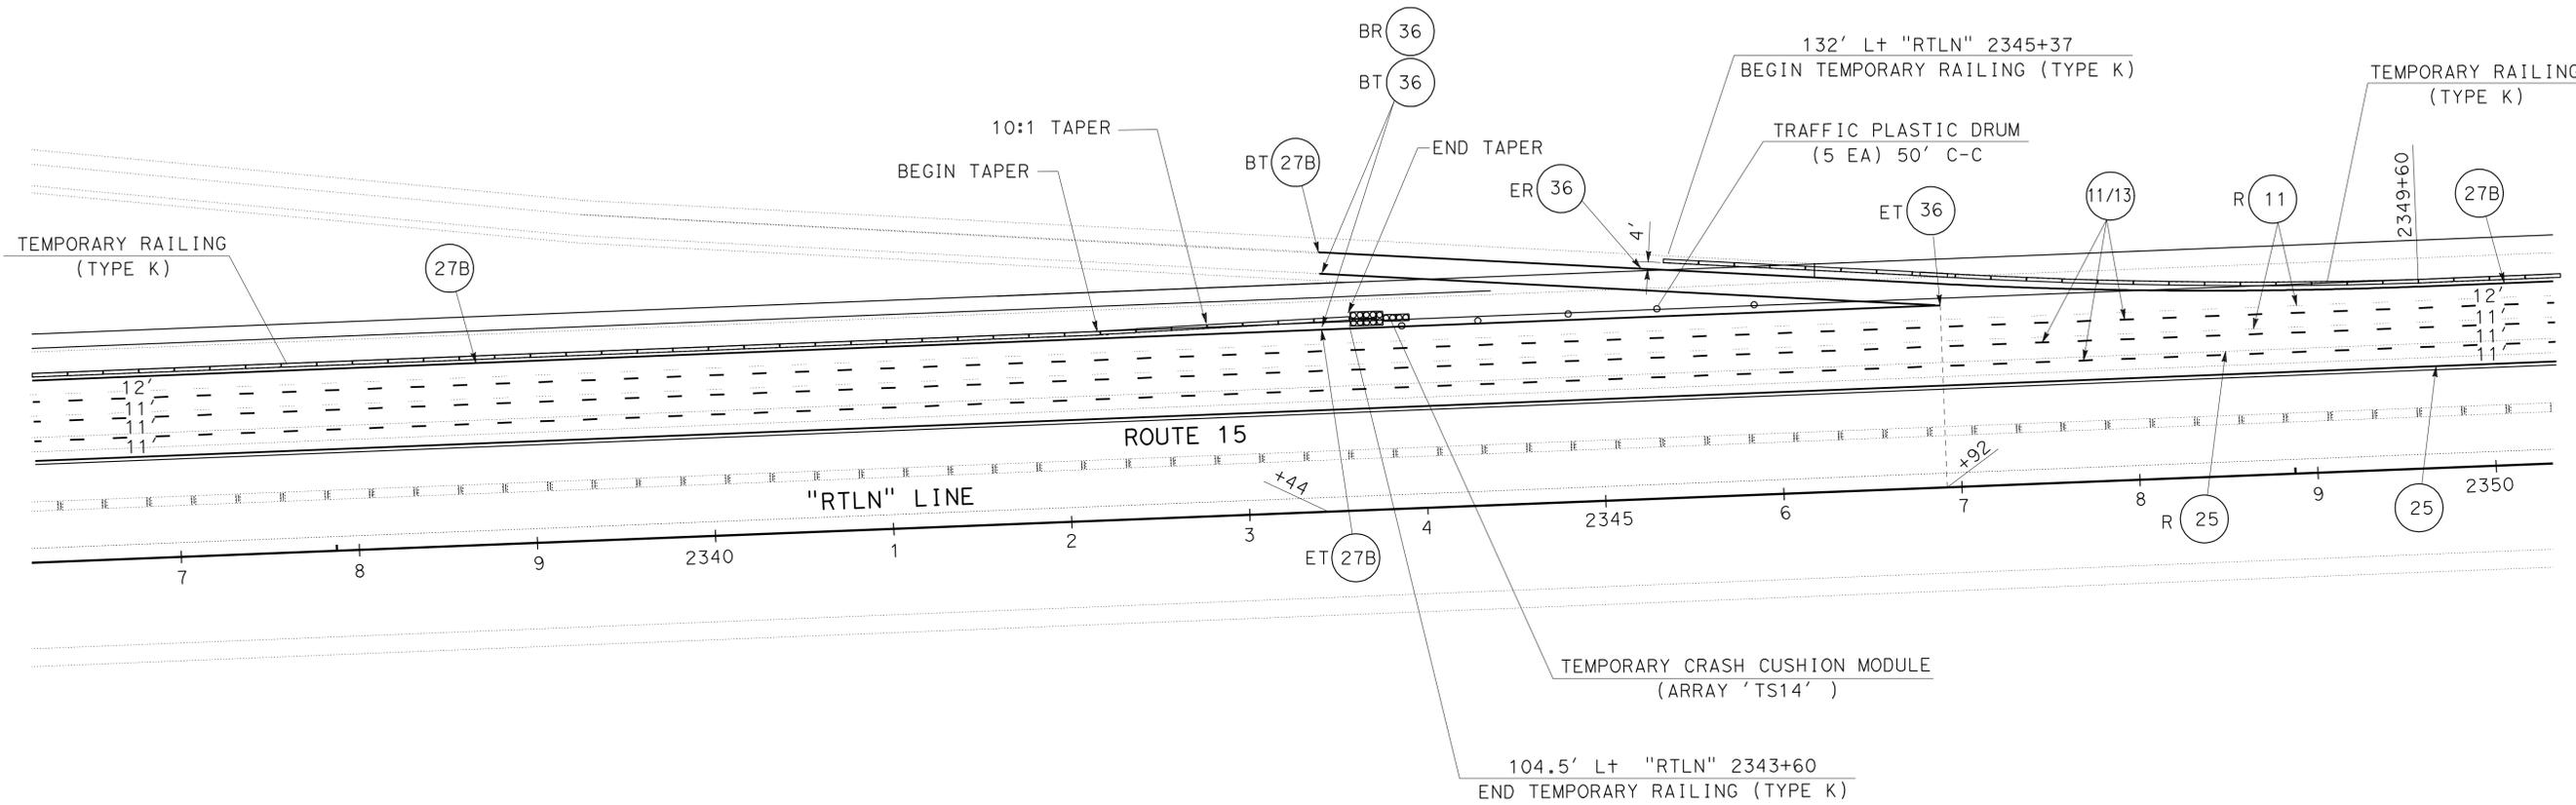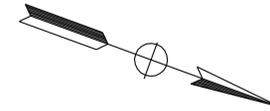THE STATE OF CALIFORNIA OR ITS OFFICERS OR AGENTS SHALL NOT BE RESPONSIBLE FOR THE ACCURACY OR COMPLETENESS OF SCANNED COPIES OF THIS PLAN SHEET.



STATE OF CALIFORNIA - DEPARTMENT OF TRANSPORTATION	DESIGN
FUNCTIONAL SUPERVISOR	CHRIS M THOMAS
CALCULATED/DESIGNED BY	CHECKED BY
SHAHRIAR SOROURBAKHSH	GARRY WILLIAMS
REVISOR BY	DATE REVISED

THIS PLAN ACCURATE FOR STAGE CONSTRUCTION WORK ONLY

**STAGE CONSTRUCTION**  
**STAGE 2**  
SCALE: 1"=50'  
**SC-5**





Dist	COUNTY	ROUTE	POST MILES TOTAL PROJECT	SHEET No.	TOTAL SHEETS
11	SD	15	R42.5/R45.9	18	46


<i>S. Sorourbaksh</i>	08-01-10
REGISTERED CIVIL ENGINEER	DATE
10-04-10	
PLANS APPROVAL DATE	

THE STATE OF CALIFORNIA OR ITS OFFICERS OR AGENTS SHALL NOT BE RESPONSIBLE FOR THE ACCURACY OR COMPLETENESS OF SCANNED COPIES OF THIS PLAN SHEET.



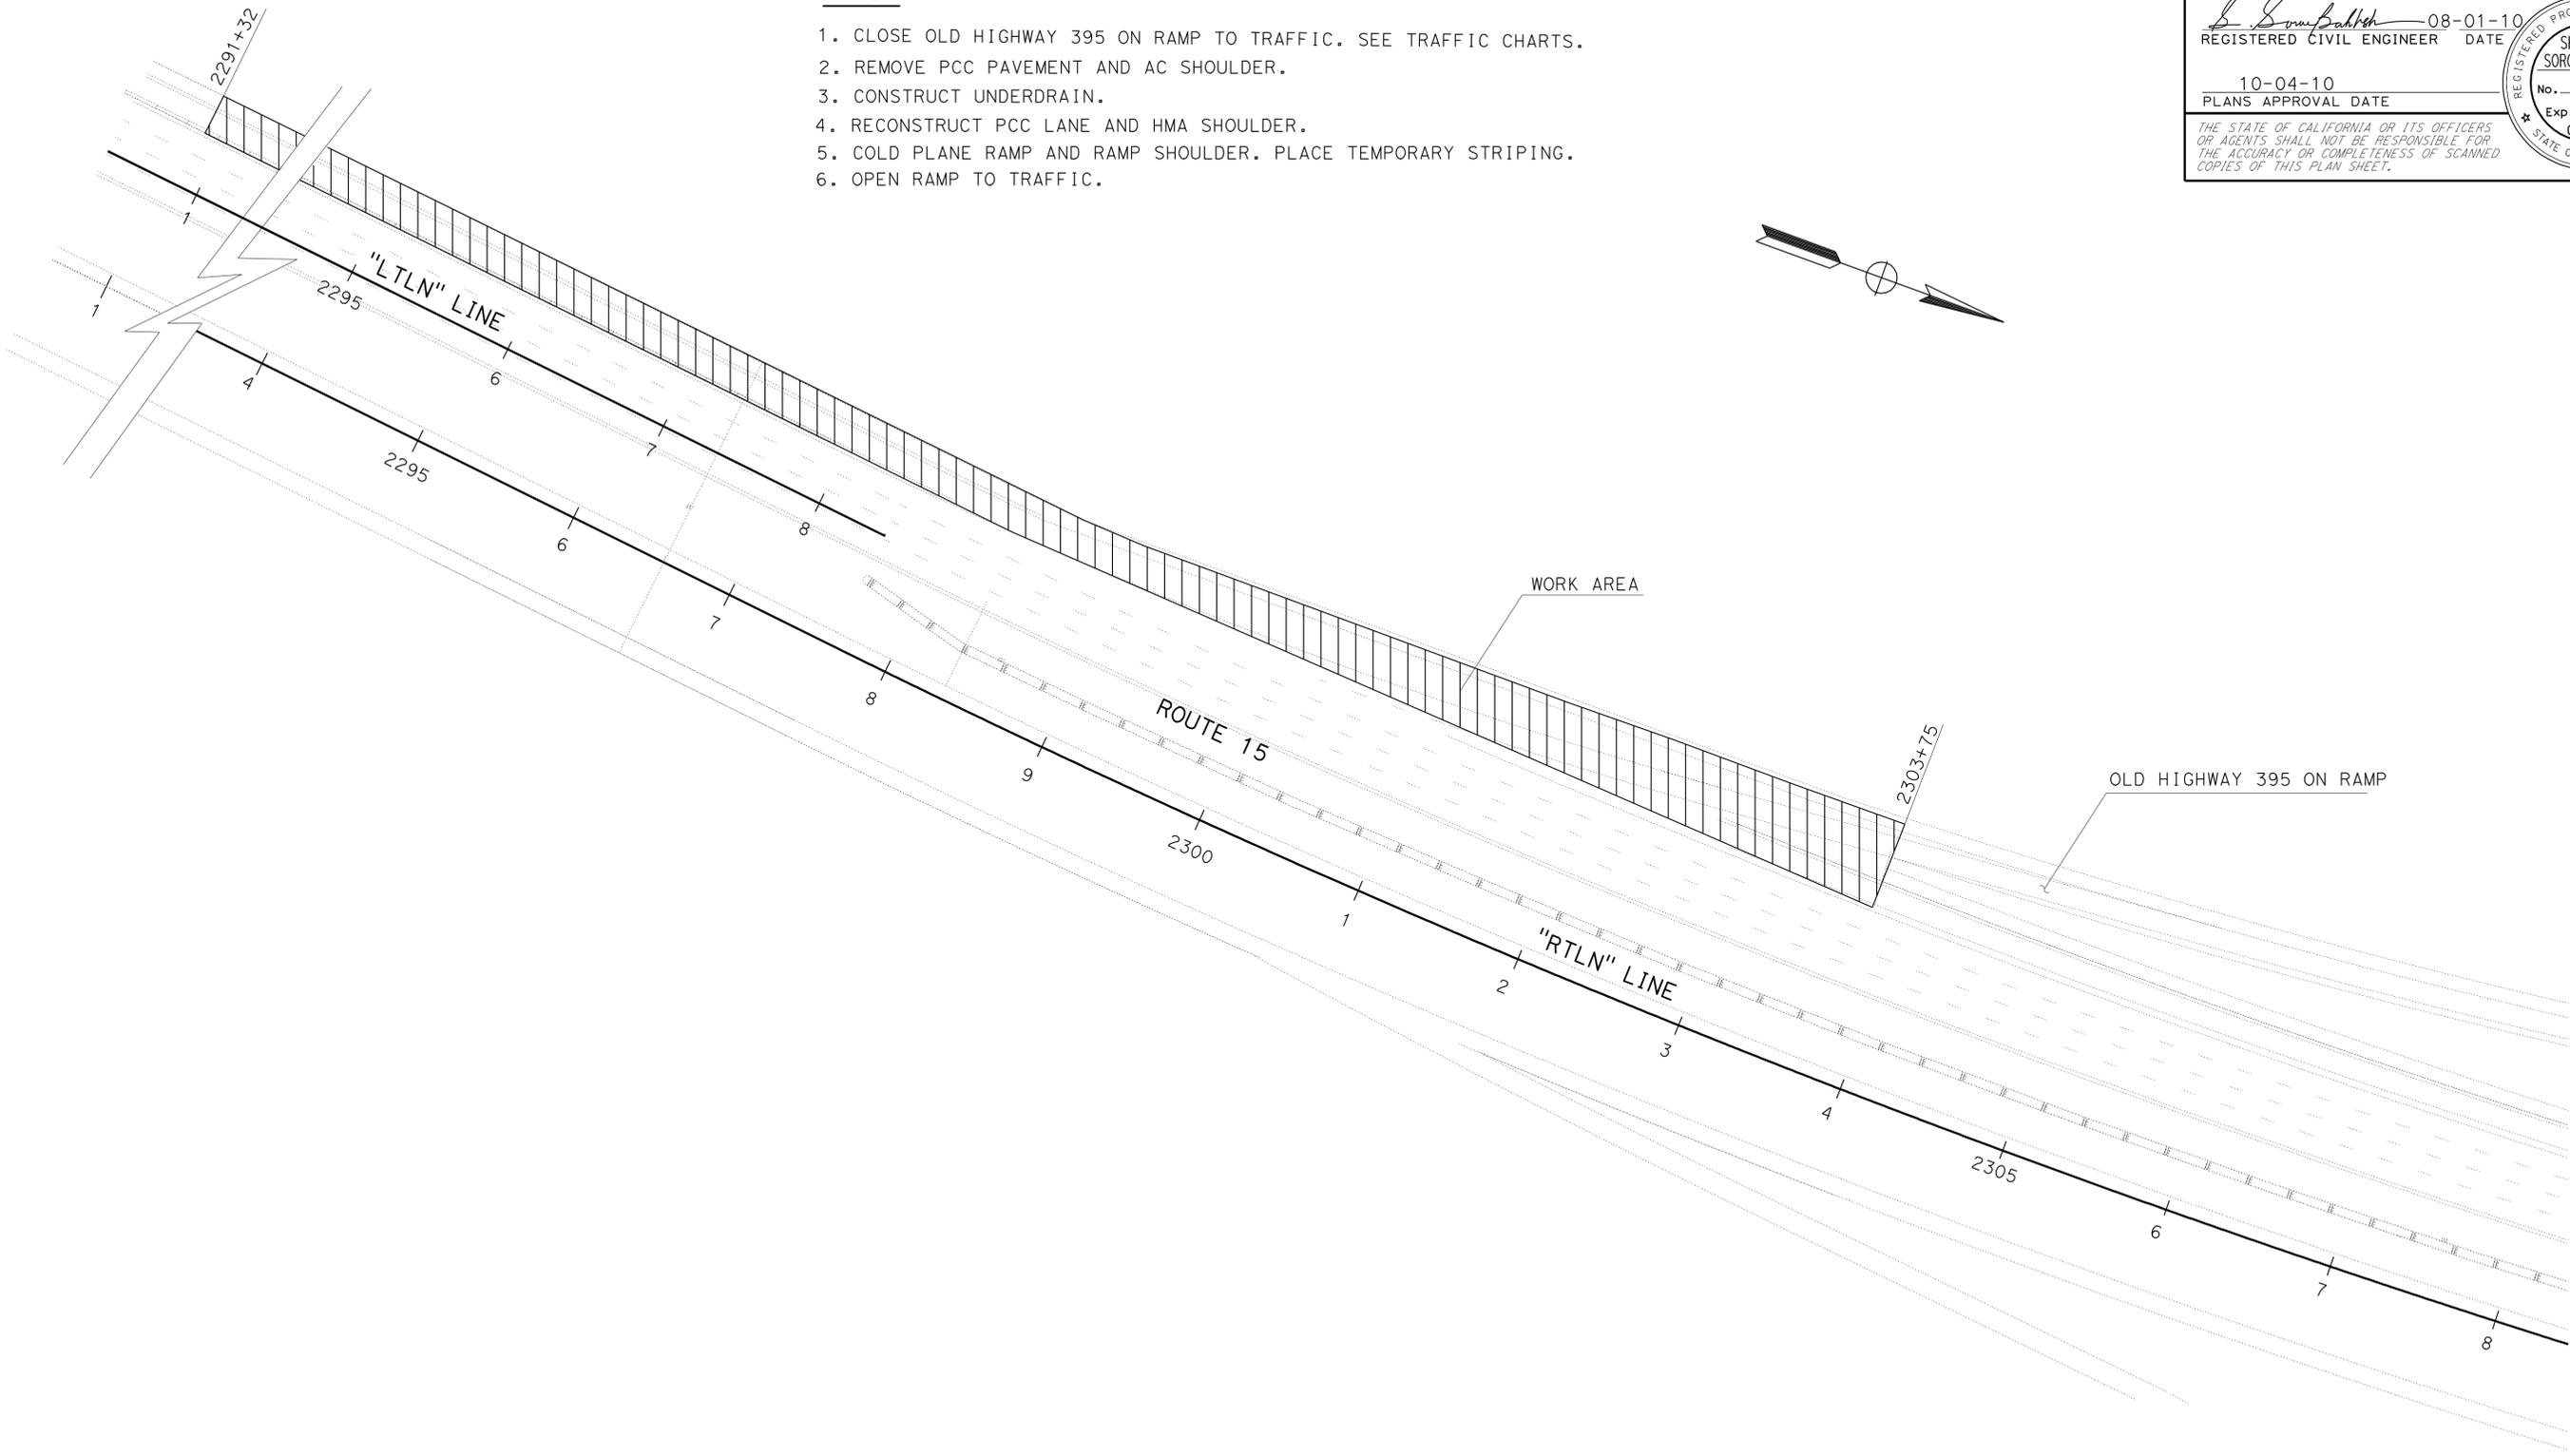- NOTES:**
1. CLOSE OLD HIGHWAY 395 ON RAMP TO TRAFFIC. SEE TRAFFIC CHARTS.
  2. REMOVE PCC PAVEMENT AND AC SHOULDER.
  3. CONSTRUCT UNDERDRAIN.
  4. RECONSTRUCT PCC LANE AND HMA SHOULDER.
  5. COLD PLANE RAMP AND RAMP SHOULDER. PLACE TEMPORARY STRIPING.
  6. OPEN RAMP TO TRAFFIC.



STATE OF CALIFORNIA - DEPARTMENT OF TRANSPORTATION	DESIGN
<b>Caltrans</b>	
FUNCTIONAL SUPERVISOR	CHRIS M THOMAS
CALCULATED/DESIGNED BY	CHECKED BY
SHAHRIAR SOROURBAKSH	GARRY WILLIAMS
REVISED BY	DATE REVISED

THIS PLAN ACCURATE FOR STAGE CONSTRUCTION WORK ONLY

**STAGE CONSTRUCTION**  
**STAGE 3**  
SCALE: 1"=50'  
**SC-7**



Dist	COUNTY	ROUTE	POST MILES TOTAL PROJECT	SHEET No.	TOTAL SHEETS
11	SD	15	R42.5/R45.9	19	46

08-01-10  
 REGISTERED CIVIL ENGINEER DATE  
 10-04-10  
 PLANS APPROVAL DATE

REGISTERED PROFESSIONAL ENGINEER  
 SHAHRIAR SOROURBAKSH  
 No. 52814  
 Exp. 12-31-11  
 CIVIL  
 STATE OF CALIFORNIA

THE STATE OF CALIFORNIA OR ITS OFFICERS OR AGENTS SHALL NOT BE RESPONSIBLE FOR THE ACCURACY OR COMPLETENESS OF SCANNED COPIES OF THIS PLAN SHEET.

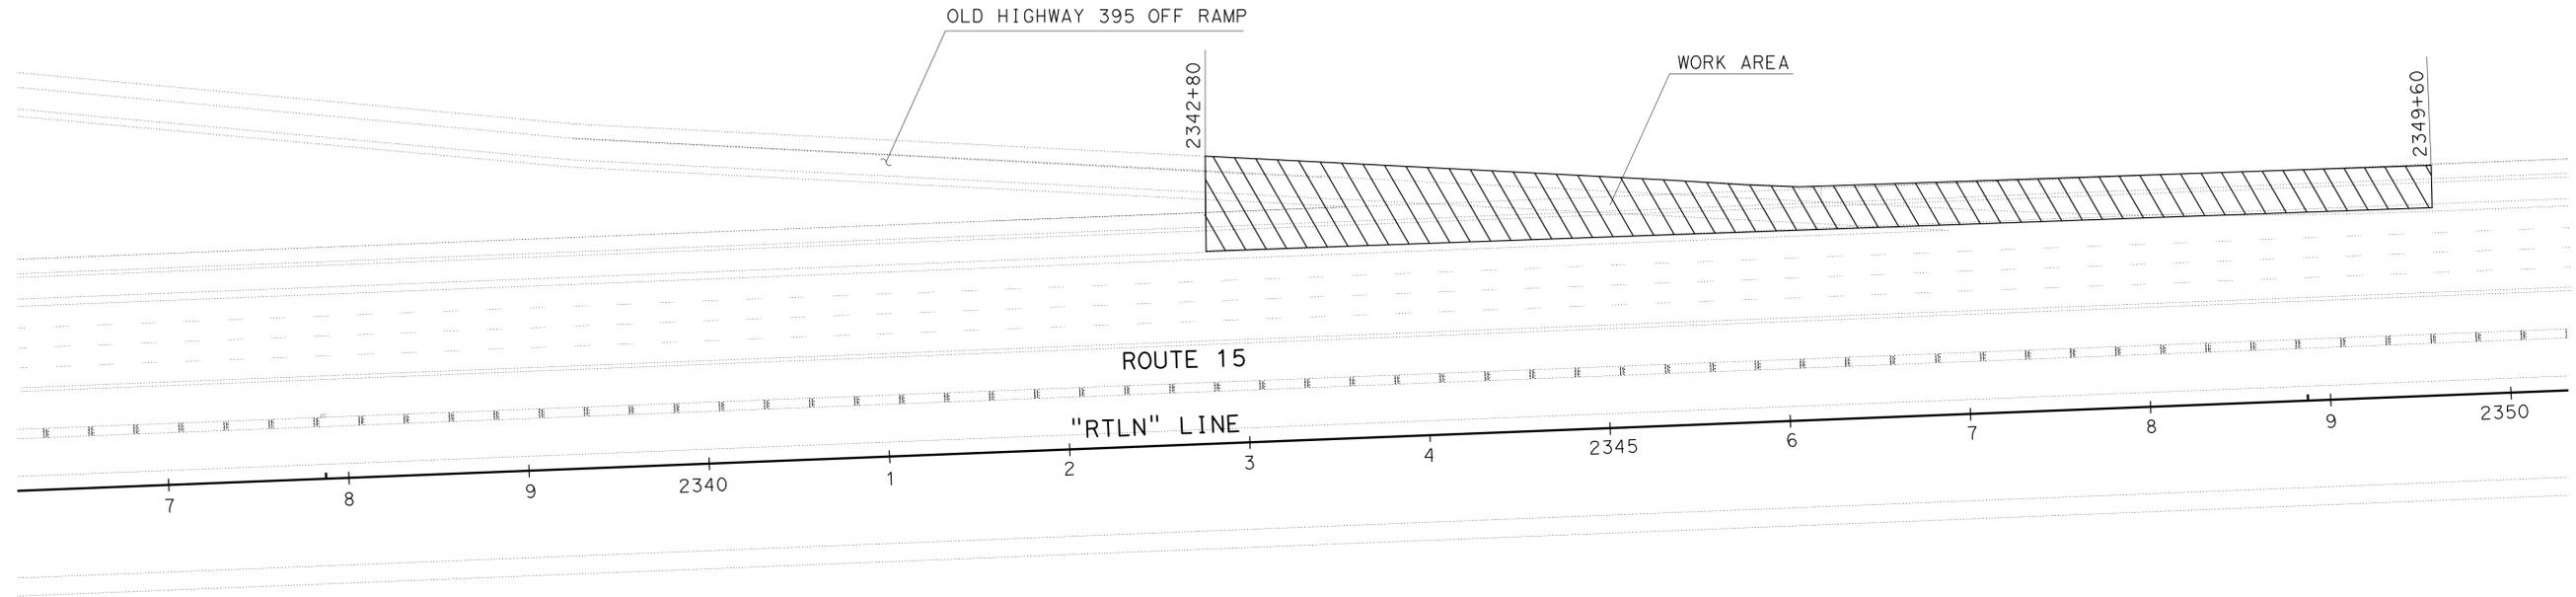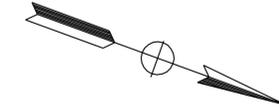- NOTES:**
1. CLOSE OLD HIGHWAY 395 OFF RAMP TO TRAFFIC. SEE TRAFFIC CHARTS.
  2. REMOVE PCC PAVEMENT AND AC SHOULDER.
  3. CONSTRUCT UNDERDRAIN.
  4. RECONSTRUCT PCC LANE AND HMA SHOULDER.
  5. COLD PLANE RAMP AND RAMP SHOULDER. PLACE TEMPORARY STRIPING.
  6. OPEN RAMP TO TRAFFIC.



STATE OF CALIFORNIA - DEPARTMENT OF TRANSPORTATION	DESIGN
Caltrans	
FUNCTIONAL SUPERVISOR	CHRIS M THOMAS
CALCULATED/DESIGNED BY	CHECKED BY
SHAHRIAR SOROURBAKSH	GARRY WILLIAMS
REVISOR	DATE

THIS PLAN ACCURATE FOR STAGE CONSTRUCTION WORK ONLY

**STAGE CONSTRUCTION**  
**STAGE 3**  
 SCALE: 1"=50'  
**SC-8**

LAST REVISION DATE PLOTTED => 01-NOV-2010  
 10-28-10 TIME PLOTTED => 14:35



Dist	COUNTY	ROUTE	POST MILES TOTAL PROJECT	SHEET No.	TOTAL SHEETS
11	SD	15	R42.5/R45.9	21	46

08-01-10  
 REGISTERED CIVIL ENGINEER DATE  
 10-04-10  
 PLANS APPROVAL DATE

REGISTERED PROFESSIONAL ENGINEER  
 SHAHRIAR SOROURBAKHSH  
 No. 52814  
 Exp. 12-31-11  
 CIVIL  
 STATE OF CALIFORNIA

THE STATE OF CALIFORNIA OR ITS OFFICERS OR AGENTS SHALL NOT BE RESPONSIBLE FOR THE ACCURACY OR COMPLETENESS OF SCANNED COPIES OF THIS PLAN SHEET.

TEMPORARY PAVEMENT DELINEATION (LESS THAN 180 DAYS)											
LOCATION			TEMPORARY PAVEMENT MARKER				TEMPORARY TRAFFIC STRIPE (PAINT)		REMOVE PAINTED TRAFFIC STRIPE	REMOVE PAVEMENT MARKER (N)	
LINE	FROM STATION	TO STATION	DETAIL No.	(EA)				(1-COAT)		(LF)	(EA)
				NON-REFLECTIVE		RETROREFLECTIVE		BROKEN STRIPE (LF)	SOLID STRIPE (LF)		
				TYPE A WHITE	TYPE C RED-CLEAR	TYPE G CLEAR	TYPE H YELLOW				
RTLN	2280+00	2463+20	11/13	4,580	-	1,145		54,960		13,740	5,725
			27B						18,320	18,320	
			25				382		18,320	18,320	382
	2301+00	2302+30	36A	6					260	260	6
	2300+20	2301+20	8					100		21	
	2302+80	2305+80	25A				13		300	300	13
	2301+20	2305+80	27B						460	460	
	2343+50	2347+00	36			29			700	700	29
SUBTOTAL				4,586		1,174	395	55,060	38,360	52,121	6,155
TOTAL				6,155				93,420		52,121 *	6,155 *

\* SEE TABLE BELOW FOR GRAND TOTAL

TEMPORARY RAILING (TYPE K)			
LINE	LOCATION	STATION LIMITS	(LF)
RTLN	SB INSIDE SHOULDER STAGE 1	2280+00 TO 2458+80	17,880
RTLN	SB OUTSIDE SHOULDER STAGE 2	2289+20 TO 2298+00	880
RTLN	SB OUTSIDE SHOULDER STAGE 2	2303+30 TO 2343+60	4,030
RTLN	SB OUTSIDE SHOULDER STAGE 2	2348+00 TO 2458+15	11,015
RTLN	SB ON RAMP STAGE 2	2298+00 TO 2304+56	656
RTLN	SB OFF RAMP STAGE 2	2345+37 TO 2348+00	263
TOTAL			34,724

TEMPORARY CRASH CUSHION MODULE				
LINE	LOCATION	STAGE	STATION LIMITS	TYPE
				TS14 (EA)
RTLN	SB LANES	2	2304+56	14
RTLN	SB LANES	2	2343+60	14
RTLN	SB LANES	2	2458+15	14
TOTAL				42

TRAFFIC PLASTIC DRUM				
LINE	LOCATION	PLAN SHEET	STAGE	(EA)
RTLN	SB LANES	SC-2	1	11
RTLN	SB LANES	SC-4	2	6
RTLN	SB LANES	SC-5	2	5
RTLN	SB LANES	SC-6	2	11
TOTAL				33

CONSTRUCTION AREA SIGNS				
SIGN No.	TYPE	PANEL SIZE (INCH)	No. OF POST AND SIZE (INCH)	No. OF SIGN
5	C31A (CA)	48 x 48	1-4 X 6 (S)	3
TOTAL				3

(S) DENOTES STATIONARY MOUNTED SIGN

REMOVE PAINTED TRAFFIC STRIPE					
LINE	LOCATION	STATION	DETAIL	(LF)	REMARKS
RTLN	SB LANES	2280+00 TO 2463+20	11	11,000	Exist
RTLN	SB LANES	2280+00 TO 2463+20	8	80	
			36A	320	
			27B	950	
			25A	200	
			36	200	
SUBTOTAL				12,750	
TOTAL FROM ABOVE TABLE				52,121	
TOTAL				64,871	

REMOVE PAVEMENT MARKER (N)				
LINE	LOCATION	STATION	DETAIL	(EA)
RTLN	SB LANES	2280+00 TO 2463+20	TYPE G	764
			TYPE A	3,054
			TYPE H	381
SUBTOTAL				4,199
TOTAL FROM ABOVE TABLE				6,155
TOTAL				10,354

(N) NOT A SEPARATE PAY ITEM, FOR INFORMATION ONLY.

## STAGE CONSTRUCTION QUANTITIES

### SCQ-1

STATE OF CALIFORNIA - DEPARTMENT OF TRANSPORTATION  
 Shahriar Sorourbaksh  
 Garry Williams  
 Chris M Thomas  
 DESIGN



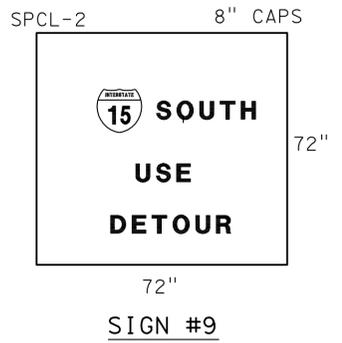
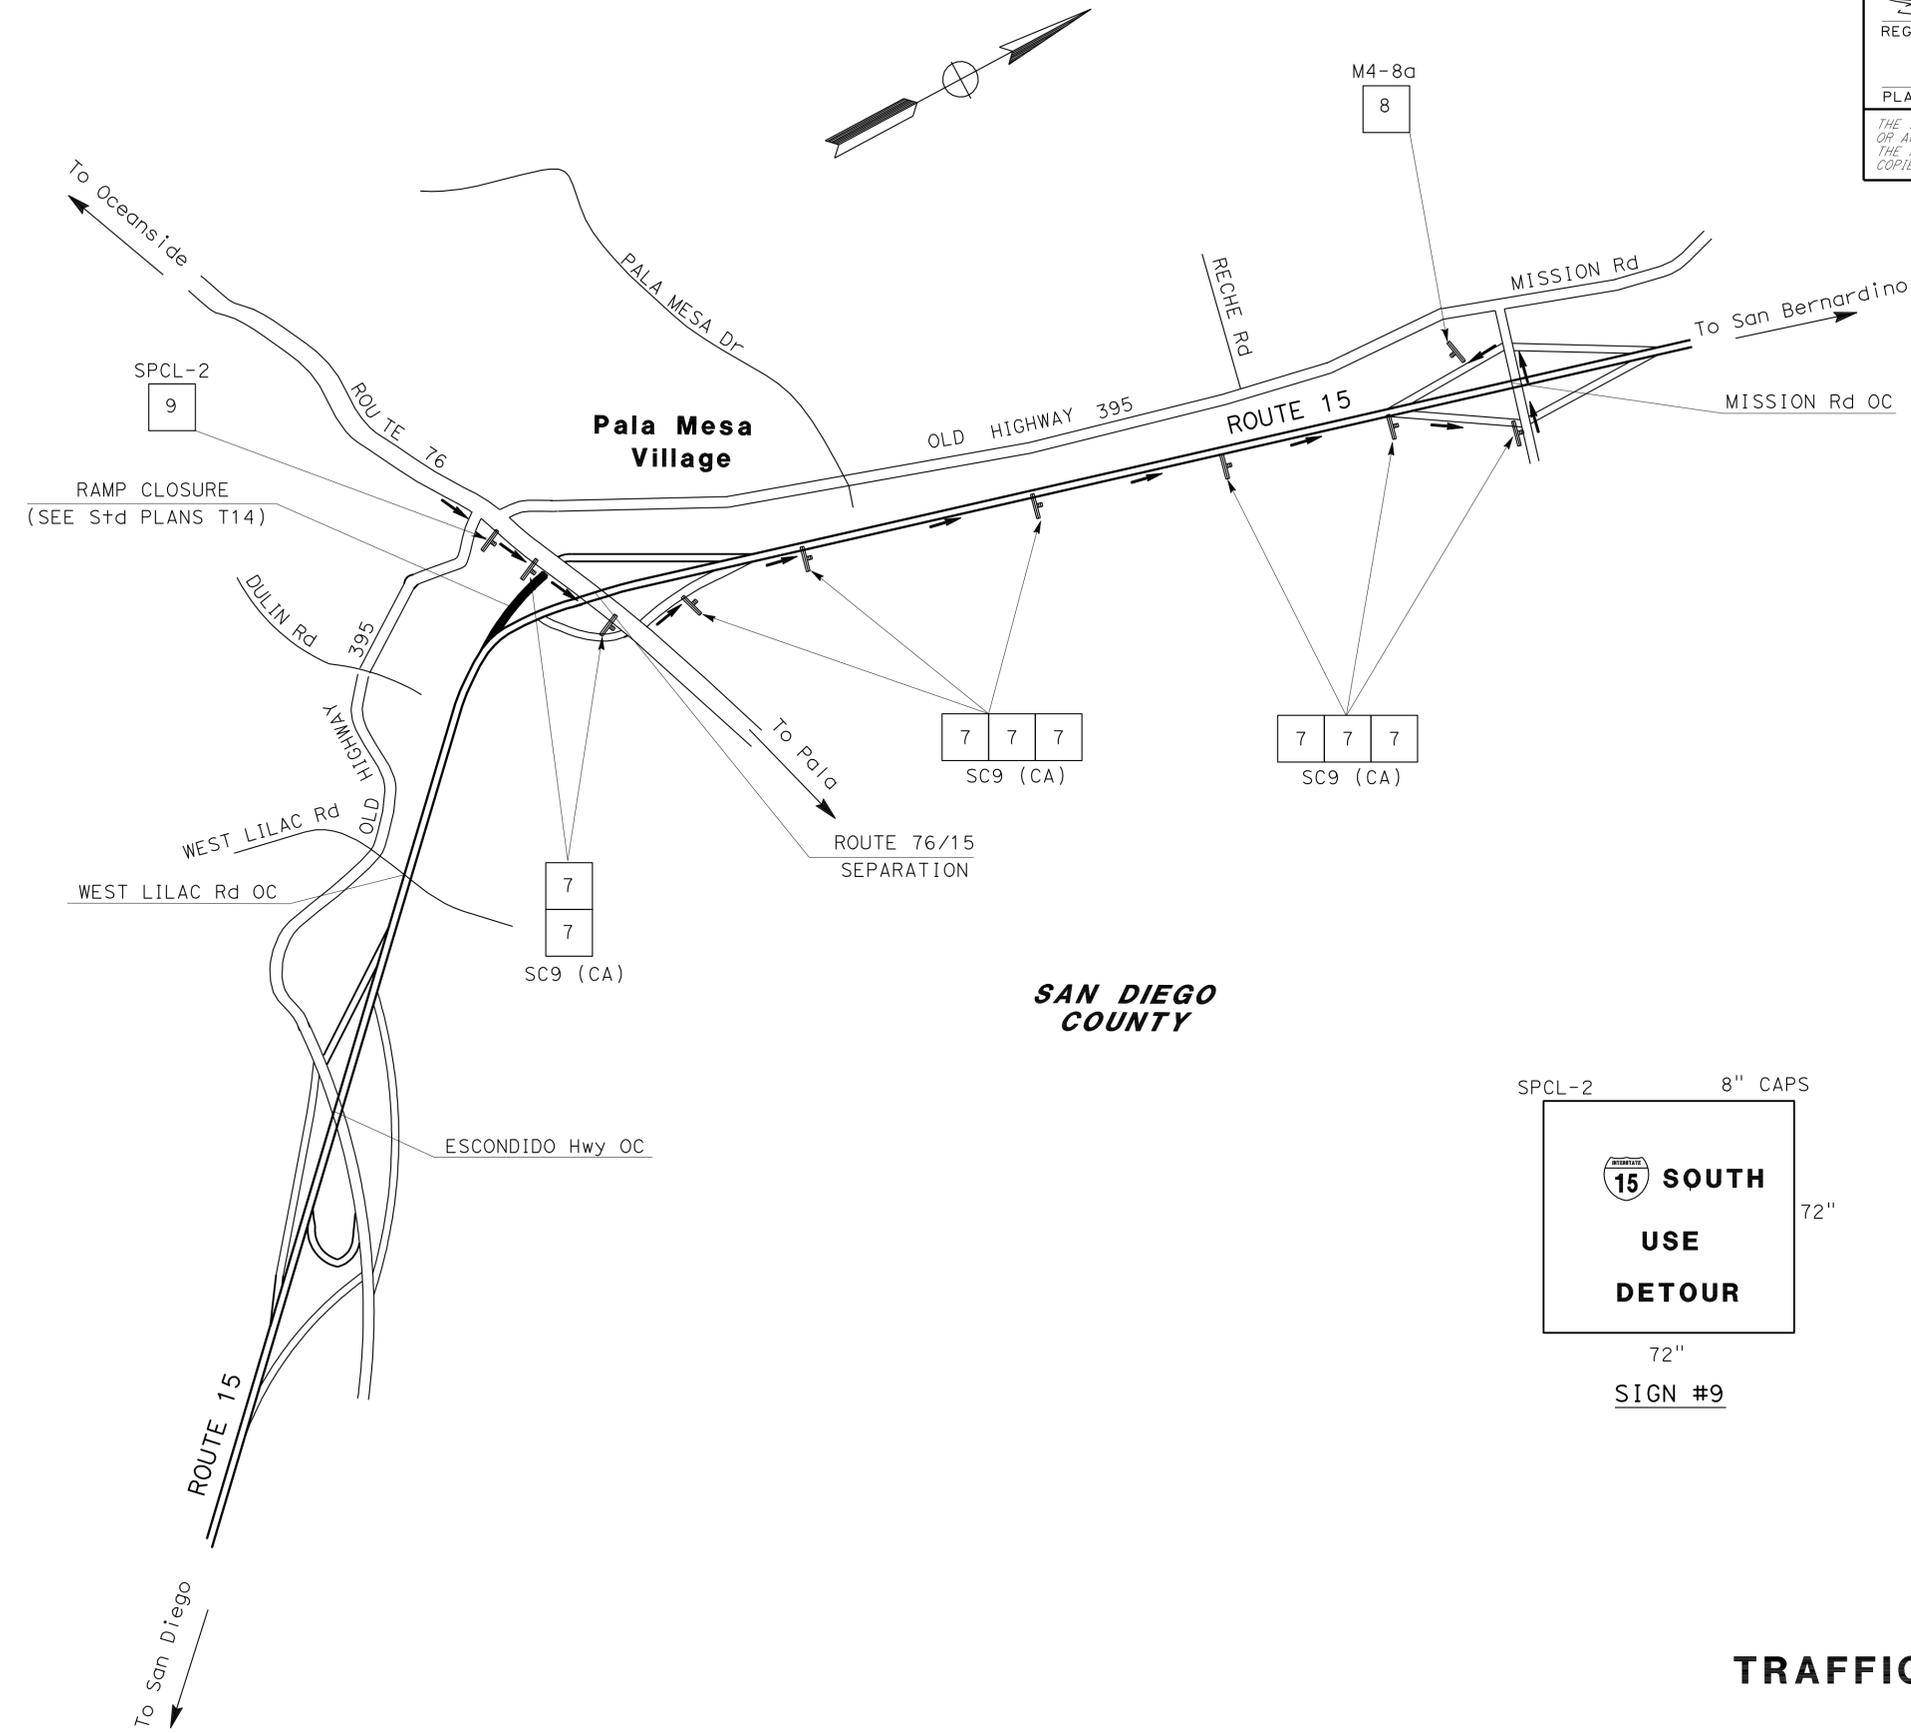
Dist	COUNTY	ROUTE	POST MILES TOTAL PROJECT	SHEET No.	TOTAL SHEETS
11	SD	15	R42.5/R45.9	23	46

09-07-10  
 REGISTERED CIVIL ENGINEER DATE  
 10-04-10  
 PLANS APPROVAL DATE

REGISTERED PROFESSIONAL ENGINEER  
 SHAHIN T. ADIBI  
 No. 54839  
 Exp. 06-30-12  
 CIVIL  
 STATE OF CALIFORNIA

THE STATE OF CALIFORNIA OR ITS OFFICERS OR AGENTS SHALL NOT BE RESPONSIBLE FOR THE ACCURACY OR COMPLETENESS OF SCANNED COPIES OF THIS PLAN SHEET.

STATE OF CALIFORNIA - DEPARTMENT OF TRANSPORTATION	FUNCTIONAL SUPERVISOR	CALCULATED/DESIGNED BY	THANH NGUYEN	REVISOR	DATE
<b>Caltrans</b>	CAMILLE ABOUFADEL	CHECKED BY	SHAHIN T ADIBI	DATE	REVISED
<b>TRAFFIC DESIGN</b>					



**TRAFFIC HANDLING PLAN**

**TH-2**

THIS PLAN IS ACCURATE FOR TRAFFIC HANDLING WORK ONLY

NO SCALE

Dist	COUNTY	ROUTE	POST MILES TOTAL PROJECT	SHEET No.	TOTAL SHEETS
11	SD	15	R42.5/R45.9	24	46

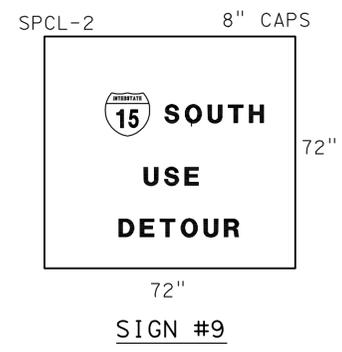
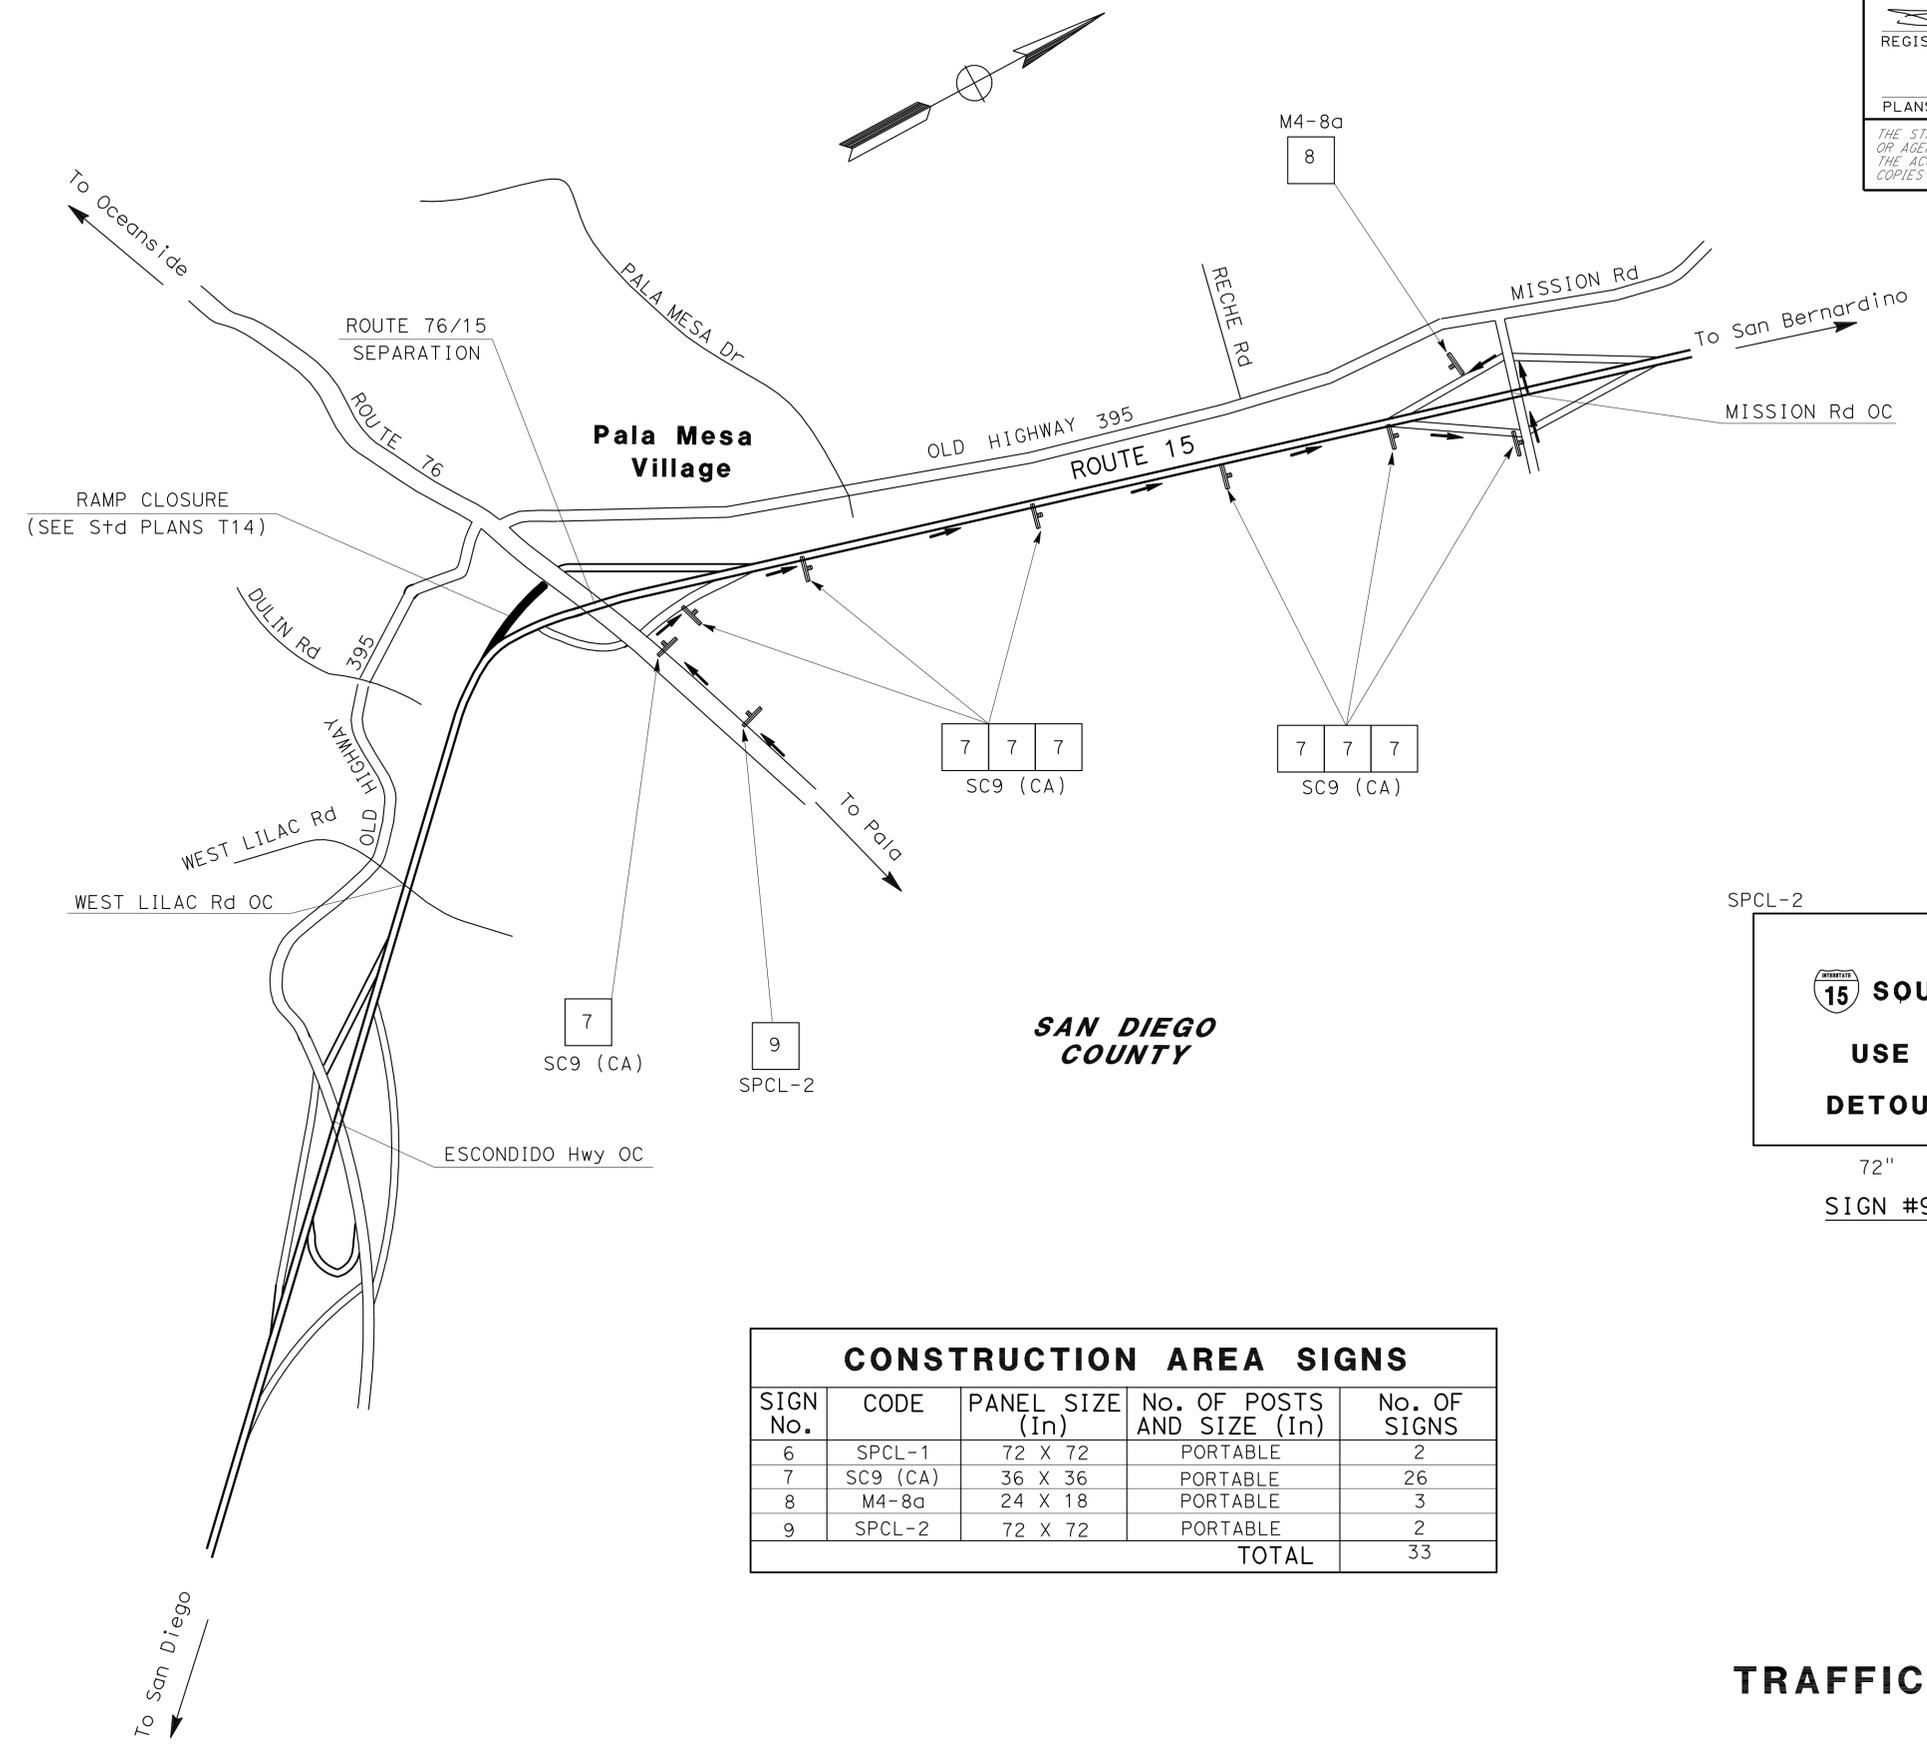
 09-07-10  
 REGISTERED CIVIL ENGINEER DATE

10-04-10  
 PLANS APPROVAL DATE

THE STATE OF CALIFORNIA OR ITS OFFICERS OR AGENTS SHALL NOT BE RESPONSIBLE FOR THE ACCURACY OR COMPLETENESS OF SCANNED COPIES OF THIS PLAN SHEET.

REGISTERED PROFESSIONAL ENGINEER  
 SHAHIN T. ADIBI  
 No. 54839  
 Exp. 06-30-12  
 CIVIL  
 STATE OF CALIFORNIA

STATE OF CALIFORNIA - DEPARTMENT OF TRANSPORTATION  
**Caltrans** TRAFFIC DESIGN  
 FUNCTIONAL SUPERVISOR: CAMILLE ABOUFADEL  
 CALCULATED/DESIGNED BY: THANH NGUYEN  
 CHECKED BY: SHAHIN T ADIBI  
 REVISED BY: THANH NGUYEN  
 DATE REVISED:



CONSTRUCTION AREA SIGNS				
SIGN No.	CODE	PANEL SIZE (In)	No. OF POSTS AND SIZE (In)	No. OF SIGNS
6	SPCL-1	72 X 72	PORTABLE	2
7	SC9 (CA)	36 X 36	PORTABLE	26
8	M4-8a	24 X 18	PORTABLE	3
9	SPCL-2	72 X 72	PORTABLE	2
TOTAL				33

**TRAFFIC HANDLING PLAN**

NO SCALE

**TH-3**

THIS PLAN IS ACCURATE FOR TRAFFIC HANDLING WORK ONLY

LAST REVISION | DATE PLOTTED => 01-NOV-2010  
 10-28-10 TIME PLOTTED => 14:35





Dist	COUNTY	ROUTE	POST MILES TOTAL PROJECT	SHEET No.	TOTAL SHEETS
11	SD	15	R42.5/R45.9	27	46

08-01-10  
 REGISTERED CIVIL ENGINEER DATE  
 10-04-10  
 PLANS APPROVAL DATE

SHAHRIAR SOROURBAKSH  
 No. 52814  
 Exp. 12-31-11  
 CIVIL

THE STATE OF CALIFORNIA OR ITS OFFICERS  
 OR AGENTS SHALL NOT BE RESPONSIBLE FOR  
 THE ACCURACY OR COMPLETENESS OF SCANNED  
 COPIES OF THIS PLAN SHEET.

### STRUCTURAL SECTION SUMMARY

LINE	LOCATION	STATION LIMITS	JPCP (CY)	CONCRETE PAVEMENT RAPID STRENGTH CONCRETE (CY)	CLASS-2 AB (CY)	HMA-A (TON)
RTLN	SB LANE 4	2289+20 TO 2291+32	110		72	107
RTLN	SB LANE 4	2303+75 TO 2342+80	2,025		1,316	1,964
RTLN	SB LANE 4	2349+60 TO 2454+50	5,439		3,536	5,277
RTLN	SB LANE (STAGE 3)	2342+80 TO 2349+60		353	229	342
RTLN	SB LANE (STAGE 3)	2291+32 TO 2303+75		645	419	625
RTLN	SB LANE (STAGE 3)	2454+50 TO 2457+80		171	111	166
RTLN	SB SHOULDER	2289+20 TO 2457+80			4,746	3,496
RTLN	SB DETOUR (STAGE 1)	2280+00 TO 2457+80			2,305	4,609
RTLN	INSIDE SHOULDER (STAGE 1)	2280+00 TO 2457+80				1,587
RTLN	ON RAMP LANE AND SHOULDER COLD PLANE HMA (STAGE 3)	2299+10 TO 2303+75				90
RTLN	OFF RAMP LANE AND SHOULDER COLD PLANE HMA (STAGE 3)	2342+80 TO 2345+80				58
TOTAL			7,574	1,169	12,734	18,321

### SEAL LONGITUDINAL ISOLATION JOINT

LINE	LOCATION	STATION LIMITS	(LF)
RTLN	SB LANE	2289+20 TO 2457+80	16,860
TOTAL			16,860

### EDGE DRAIN REMOVAL (N)

LINE	LOCATION	STATION LIMITS	(LF)
RTLN	SB SHOULDER	2289+20 TO 2457+80	16,860

### EROSION CONTROL (BONDED FIBER MATRIX)

LINE	LOCATION	STATION LIMITS	(SQFT)
RTLN	SB MEDIAN	2280+00 TO 2457+80	124,460

### TEMPORARY CONCRETE WASHOUT FACILITY

LINE	LOCATION	STATION LIMITS	(EA)
RTLN	SB SHOULDER	2280+00 TO 2457+80	9

### TEMPORARY DRAINAGE INLET PROTECTION

LINE	LOCATION	STATION LIMITS	(EA)
RTLN	SB SHOULDER		27

### ASPHALTIC EMULSION (FOG SEAL COAT)

LINE	LOCATION	STATION LIMITS	(TON)
RTLN	SB SHOULDER	2289+20 TO 2457+80	5.33

## SUMMARY OF QUANTITIES Q-1

(N) NOT A SEPARATE PAT ITEM, FOR INFORMATION ONLY.

STATE OF CALIFORNIA - DEPARTMENT OF TRANSPORTATION  
 Shahriar Sorourbaksh  
 Garry Williams  
 Chris M Thomas  
 DESIGN

### COLD PLANE ASPHALT CONCRETE PAVEMENT

LINE	LOCATION	STATION LIMITS	(SQYD)
RTLN	INSIDE SHOULDER STAGE 1	2280+00 TO 2457+80	15,804
RTLN	ON RAMP LANE AND SHOULDER	2299+10 TO 2303+75	904
RTLN	OFF RAMP LANE AND SHOULDER	2342+80 TO 2345+80	584
TOTAL			17,292

### REMOVE CONCRETE PAVEMENT AND BASE

LINE	LOCATION	STATION LIMITS	(CY)
RTLN	SB LANE 4	2289+20 TO 2457+80	9375

### ROADWAY EXCAVATION

LINE	LOCATION	STATION LIMITS	(CY)
RTLN	SB SHOULDER	2289+20 TO 2457+80	6494
RTLN	SB LANE	2289+20 TO 2457+80	9430
RTLN	DETOUR	2280+00 TO 2457+80	4610
RTLN	DETOUR REMOVAL	2280+00 TO 2457+80	4610
TOTAL			25,144

### GRIND EXISTING CONCRETE PAVEMENT

LINE	LOCATION	STATION LIMITS	(SQYD)
RTLN	SB LANE	2289+20 TO 2457+80	22,480

### SHOULDER RUMBLE STRIP (CONCRETE PAVEMENT, ROLLED-IN INDENTATIONS)

LINE	LOCATION	STATION LIMITS	(STA)
RTLN	SB SHOULDER	2289+20 TO 2298+70	9.50
RTLN	SB SHOULDER	2303+75 TO 2342+80	39.05
RTLN	SB SHOULDER	2347+80 TO 2458+80	112
TOTAL			160.55

### MINOR HOT MIX ASPHALT

LINE	LOCATION	STATION LIMITS	(TON)
RTLN	SB DIKE	2289+20 TO 2457+80	417

### PLACE HOT MIX ASPHALT DIKE

LINE	LOCATION	STATION LIMITS	TYPE E (LF)
RTLN	SB SHOULDER	2289+20 TO 2298+70	950
RTLN	SB SHOULDER	2303+75 TO 2342+80	3905
RTLN	SB SHOULDER	2345+80 TO 2458+48	11,200
TOTAL			16,055

### TACK COAT

LINE	LOCATION	STATION LIMITS	TON
RTLN	SB SHOULDER	2289+20 TO 2457+80	3.55
RTLN	SB TEMPORARY DETOUR	2289+20 TO 2457+80	3.11
TOTAL			6.66



Dist	COUNTY	ROUTE	POST MILES TOTAL PROJECT	SHEET No.	TOTAL SHEETS
11	SD	15	R42.5/R45.9	29	46

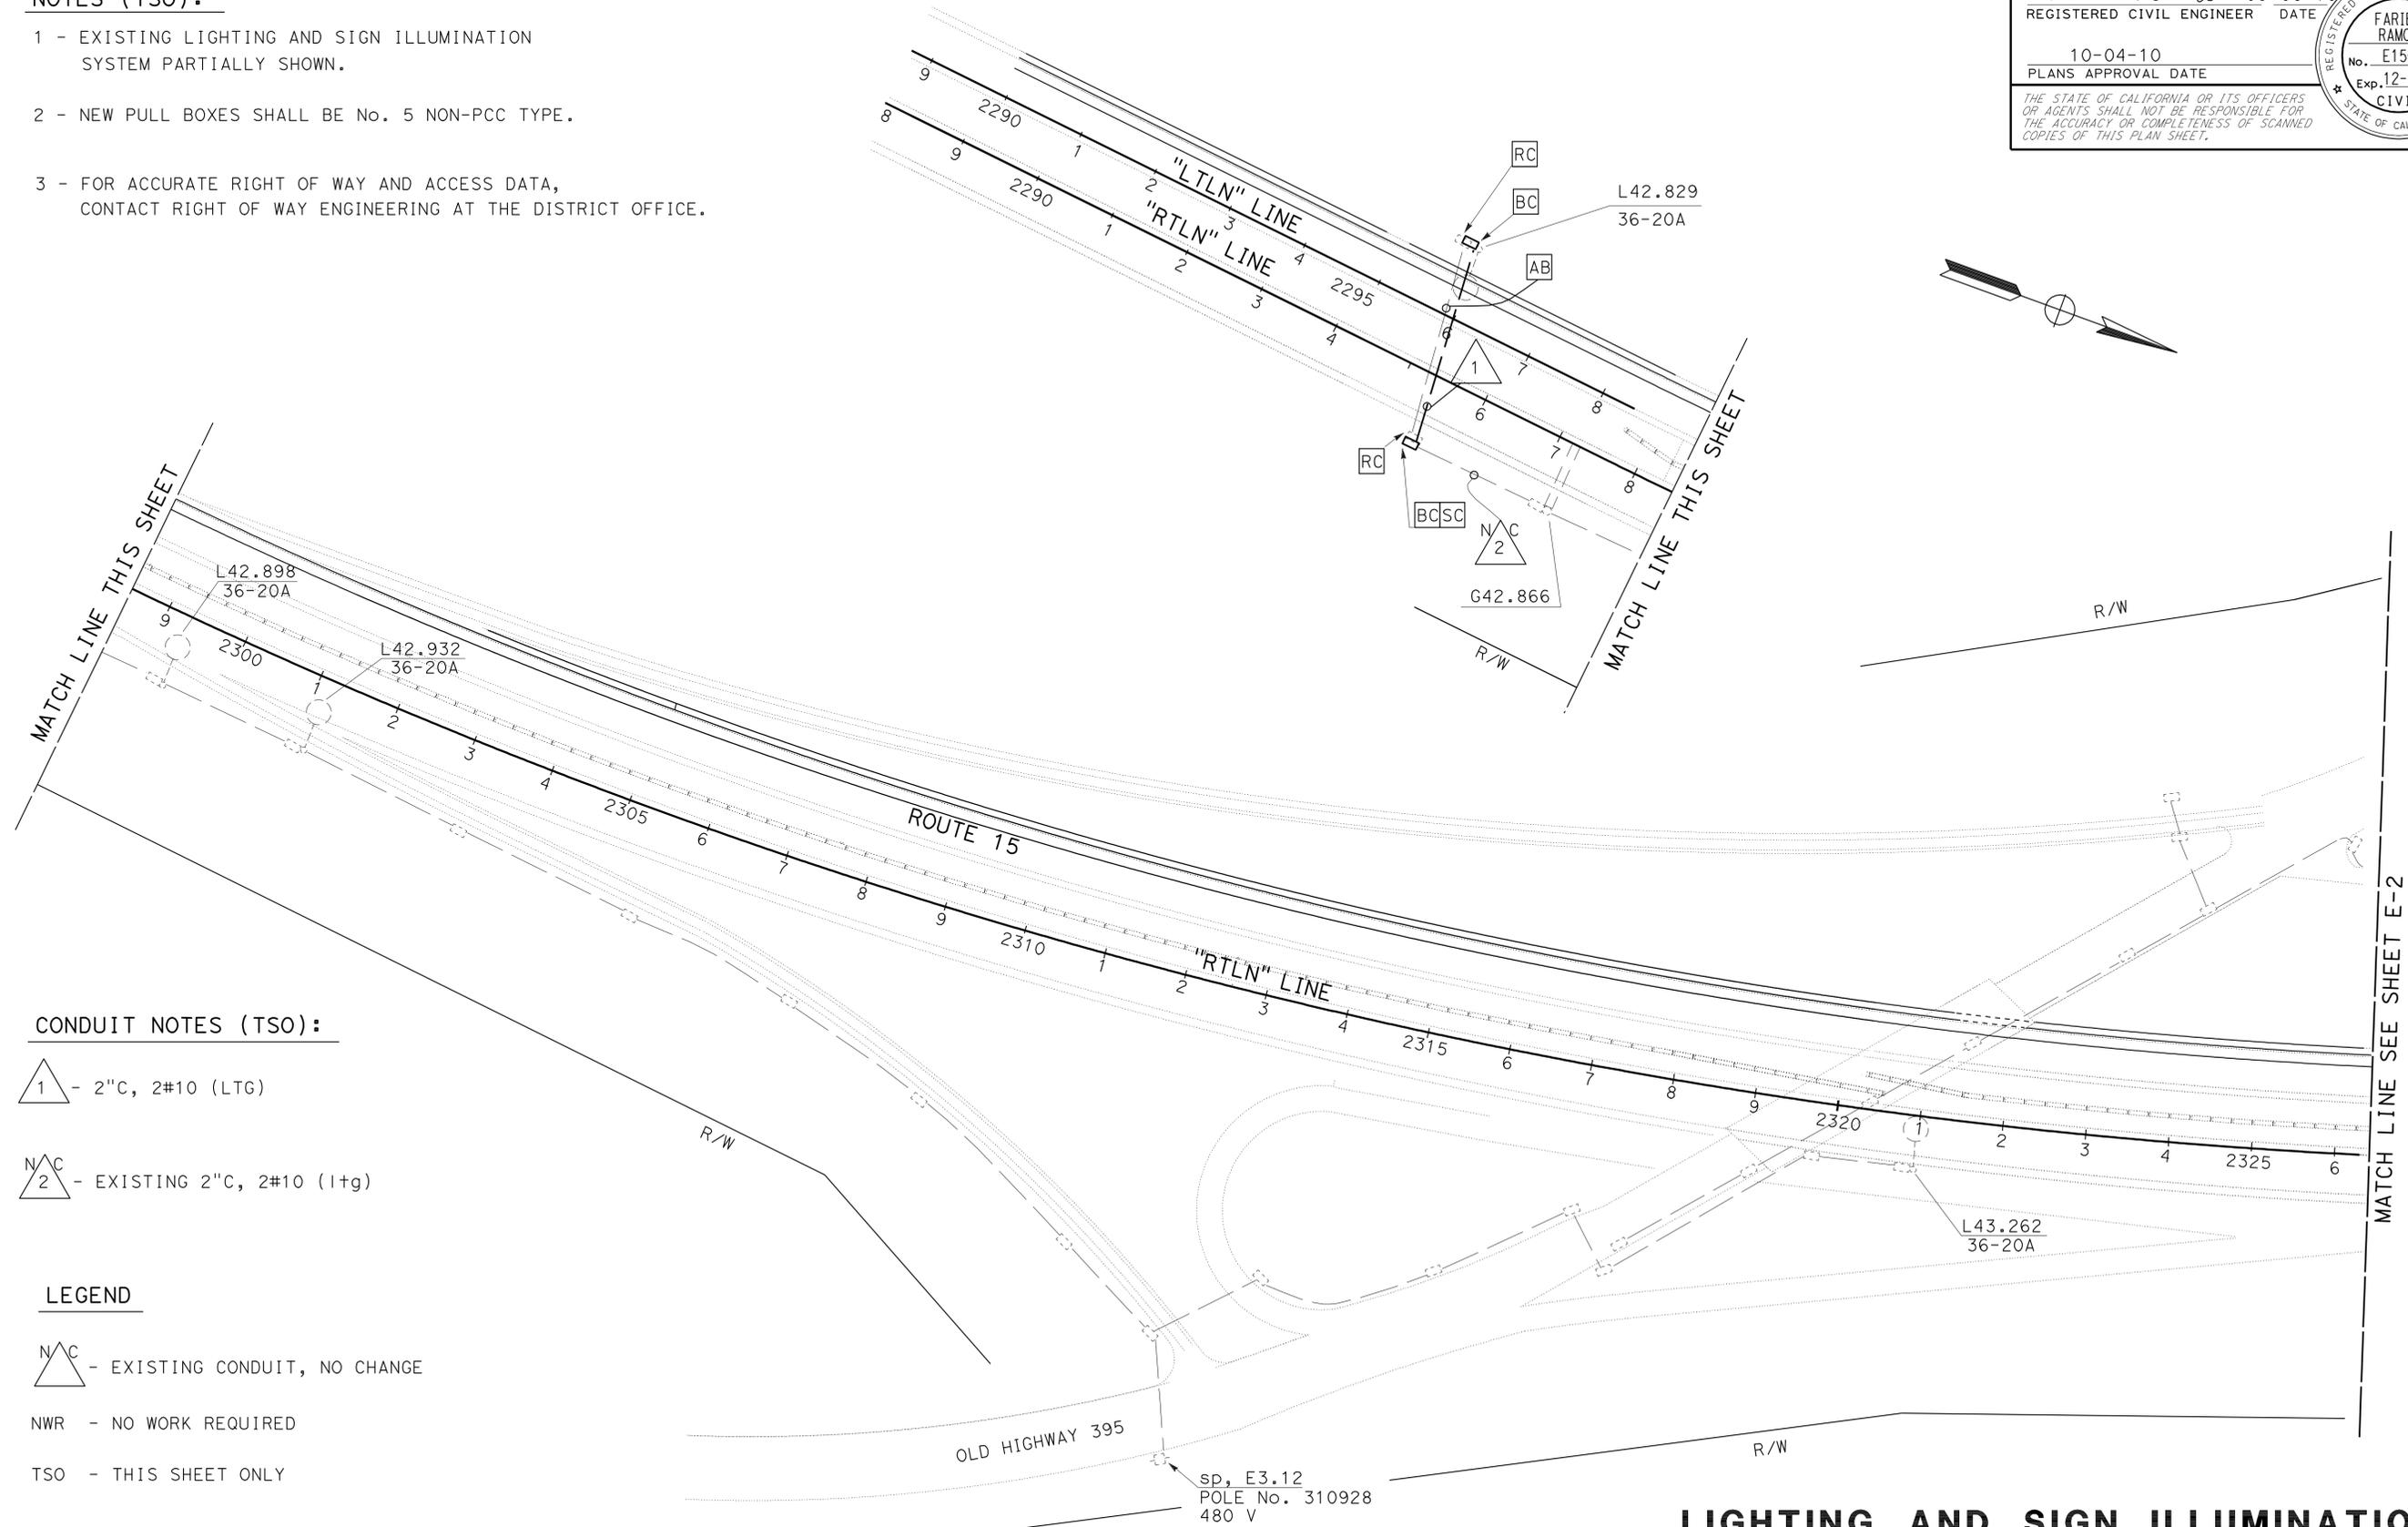
  

<i>Fauk Ramos</i> 09-08-10		REGISTERED PROFESSIONAL ENGINEER No. E15619 Exp. 12-31-11 CIVIL STATE OF CALIFORNIA
REGISTERED CIVIL ENGINEER DATE		
10-04-10		PLANS APPROVAL DATE

THE STATE OF CALIFORNIA OR ITS OFFICERS OR AGENTS SHALL NOT BE RESPONSIBLE FOR THE ACCURACY OR COMPLETENESS OF SCANNED COPIES OF THIS PLAN SHEET.

**NOTES (TSO):**

- 1 - EXISTING LIGHTING AND SIGN ILLUMINATION SYSTEM PARTIALLY SHOWN.
- 2 - NEW PULL BOXES SHALL BE No. 5 NON-PCC TYPE.
- 3 - FOR ACCURATE RIGHT OF WAY AND ACCESS DATA, CONTACT RIGHT OF WAY ENGINEERING AT THE DISTRICT OFFICE.



**CONDUIT NOTES (TSO):**

- 1 - 2"C, 2#10 (LTG)
- N/C 2 - EXISTING 2"C, 2#10 (1tg)

**LEGEND**

- N/C - EXISTING CONDUIT, NO CHANGE
- NWR - NO WORK REQUIRED
- TSO - THIS SHEET ONLY

THIS PLAN IS ACCURATE FOR ELECTRICAL WORK ONLY.

**LIGHTING AND SIGN ILLUMINATION**

SCALE: 1"=100'

**E-1**

STATE OF CALIFORNIA - DEPARTMENT OF TRANSPORTATION	FUNCTIONAL SUPERVISOR	REVISOR	DATE
<b>Caltrans</b> - DEPARTMENT OF TRANSPORTATION	DALE WILSON	FARIBA RAMOS	
<b>TRAFFIC ELECTRICAL</b>		ENRIQUE BERNAL	
		CHECKED BY	DATE
		DESIGNED BY	
		REVISOR	DATE
		REVISOR	DATE



Dist	COUNTY	ROUTE	POST MILES TOTAL PROJECT	SHEET No.	TOTAL SHEETS
11	SD	15	R42.5/R45.9	30	46
<i>Fauk Ramos</i> 09-08-10 REGISTERED CIVIL ENGINEER DATE					
10-04-10 PLANS APPROVAL DATE			THE STATE OF CALIFORNIA OR ITS OFFICERS OR AGENTS SHALL NOT BE RESPONSIBLE FOR THE ACCURACY OR COMPLETENESS OF SCANNED COPIES OF THIS PLAN SHEET.		

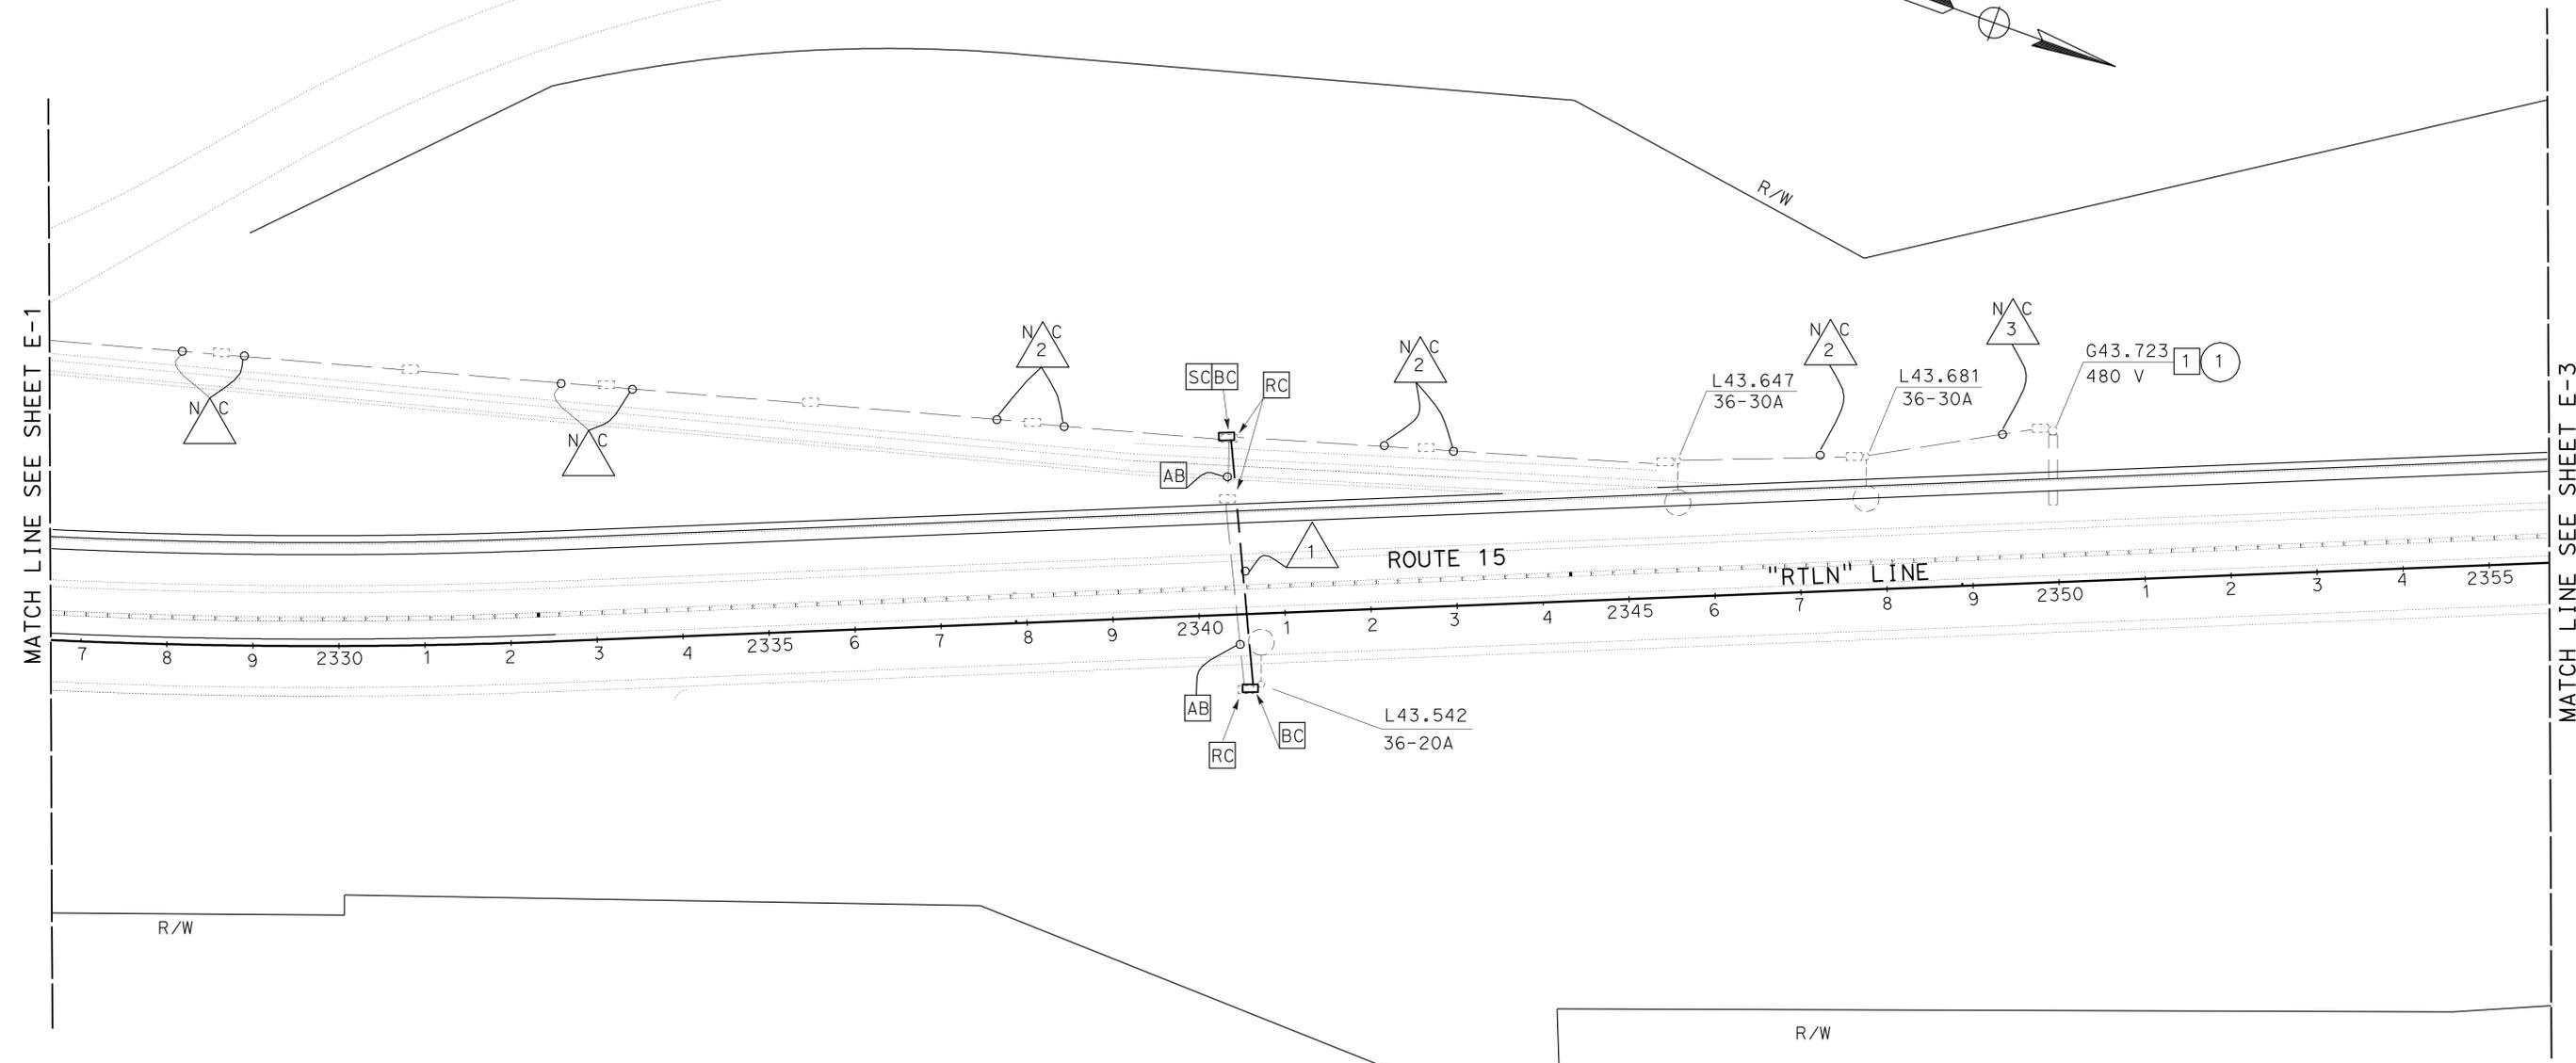
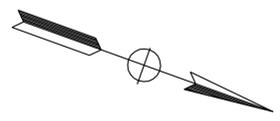
**NOTES (TSO):**

- 1 - **RS** SIGN LIGHTING FIXTURES AND SIGN CONTROL.  
SEE E-1 FOR SERVICE POINT, E3.12, 480 V.
- 2 - EXISTING LIGHTING AND SIGN ILLUMINATION SYSTEM PARTIALLY SHOWN.
- 3 - NEW PULL BOXES SHALL BE No. 5 NON-PCC TYPE.

FOR ACCURATE RIGHT OF WAY AND ACCESS DATA, CONTACT RIGHT OF WAY ENGINEERING AT THE DISTRICT OFFICE.

**CONDUIT NOTES (TSO):**

- 2" C, 2#10 (LTG)
- EXISTING 2" C, 2#10 (LTG)  
2#10 (SIGN)
- EXISTING 2" C, 2#10 (SIGN)



ILLUMINATED SIGNS AND APPURTENANCES				
SIGN No.	QUANTITY OF 85 W ISL FIXTURES	VOLTAGE	LOAD	REMARKS
1	2	480 V	174 W	SEE S+D PLANS ES-15A

THIS PLAN IS ACCURATE FOR ELECTRICAL WORK ONLY.

**LIGHTING AND SIGN ILLUMINATION**

SCALE: 1"=100'

**E-2**

STATE OF CALIFORNIA - DEPARTMENT OF TRANSPORTATION  
**Caltrans** TRAFFIC ELECTRICAL  
 FUNCTIONAL SUPERVISOR: DALE WILSON  
 CALCULATED/DESIGNED BY: ENRIQUE BERNAL  
 CHECKED BY: FARIBA RAMOS  
 REVISOR: ENRIQUE BERNAL  
 DATE REVISOR: FARIBA RAMOS

Dist	COUNTY	ROUTE	POST MILES TOTAL PROJECT	SHEET No.	TOTAL SHEETS
11	SD	15	R42.5/R45.9	31	46

<i>Fauk Ramos</i> 09-08-10		REGISTERED PROFESSIONAL ENGINEER STATE OF CALIFORNIA
REGISTERED CIVIL ENGINEER DATE		
10-04-10		No. E15619 Exp. 12-31-11 CIVIL
PLANS APPROVAL DATE		

THE STATE OF CALIFORNIA OR ITS OFFICERS OR AGENTS SHALL NOT BE RESPONSIBLE FOR THE ACCURACY OR COMPLETENESS OF SCANNED COPIES OF THIS PLAN SHEET.

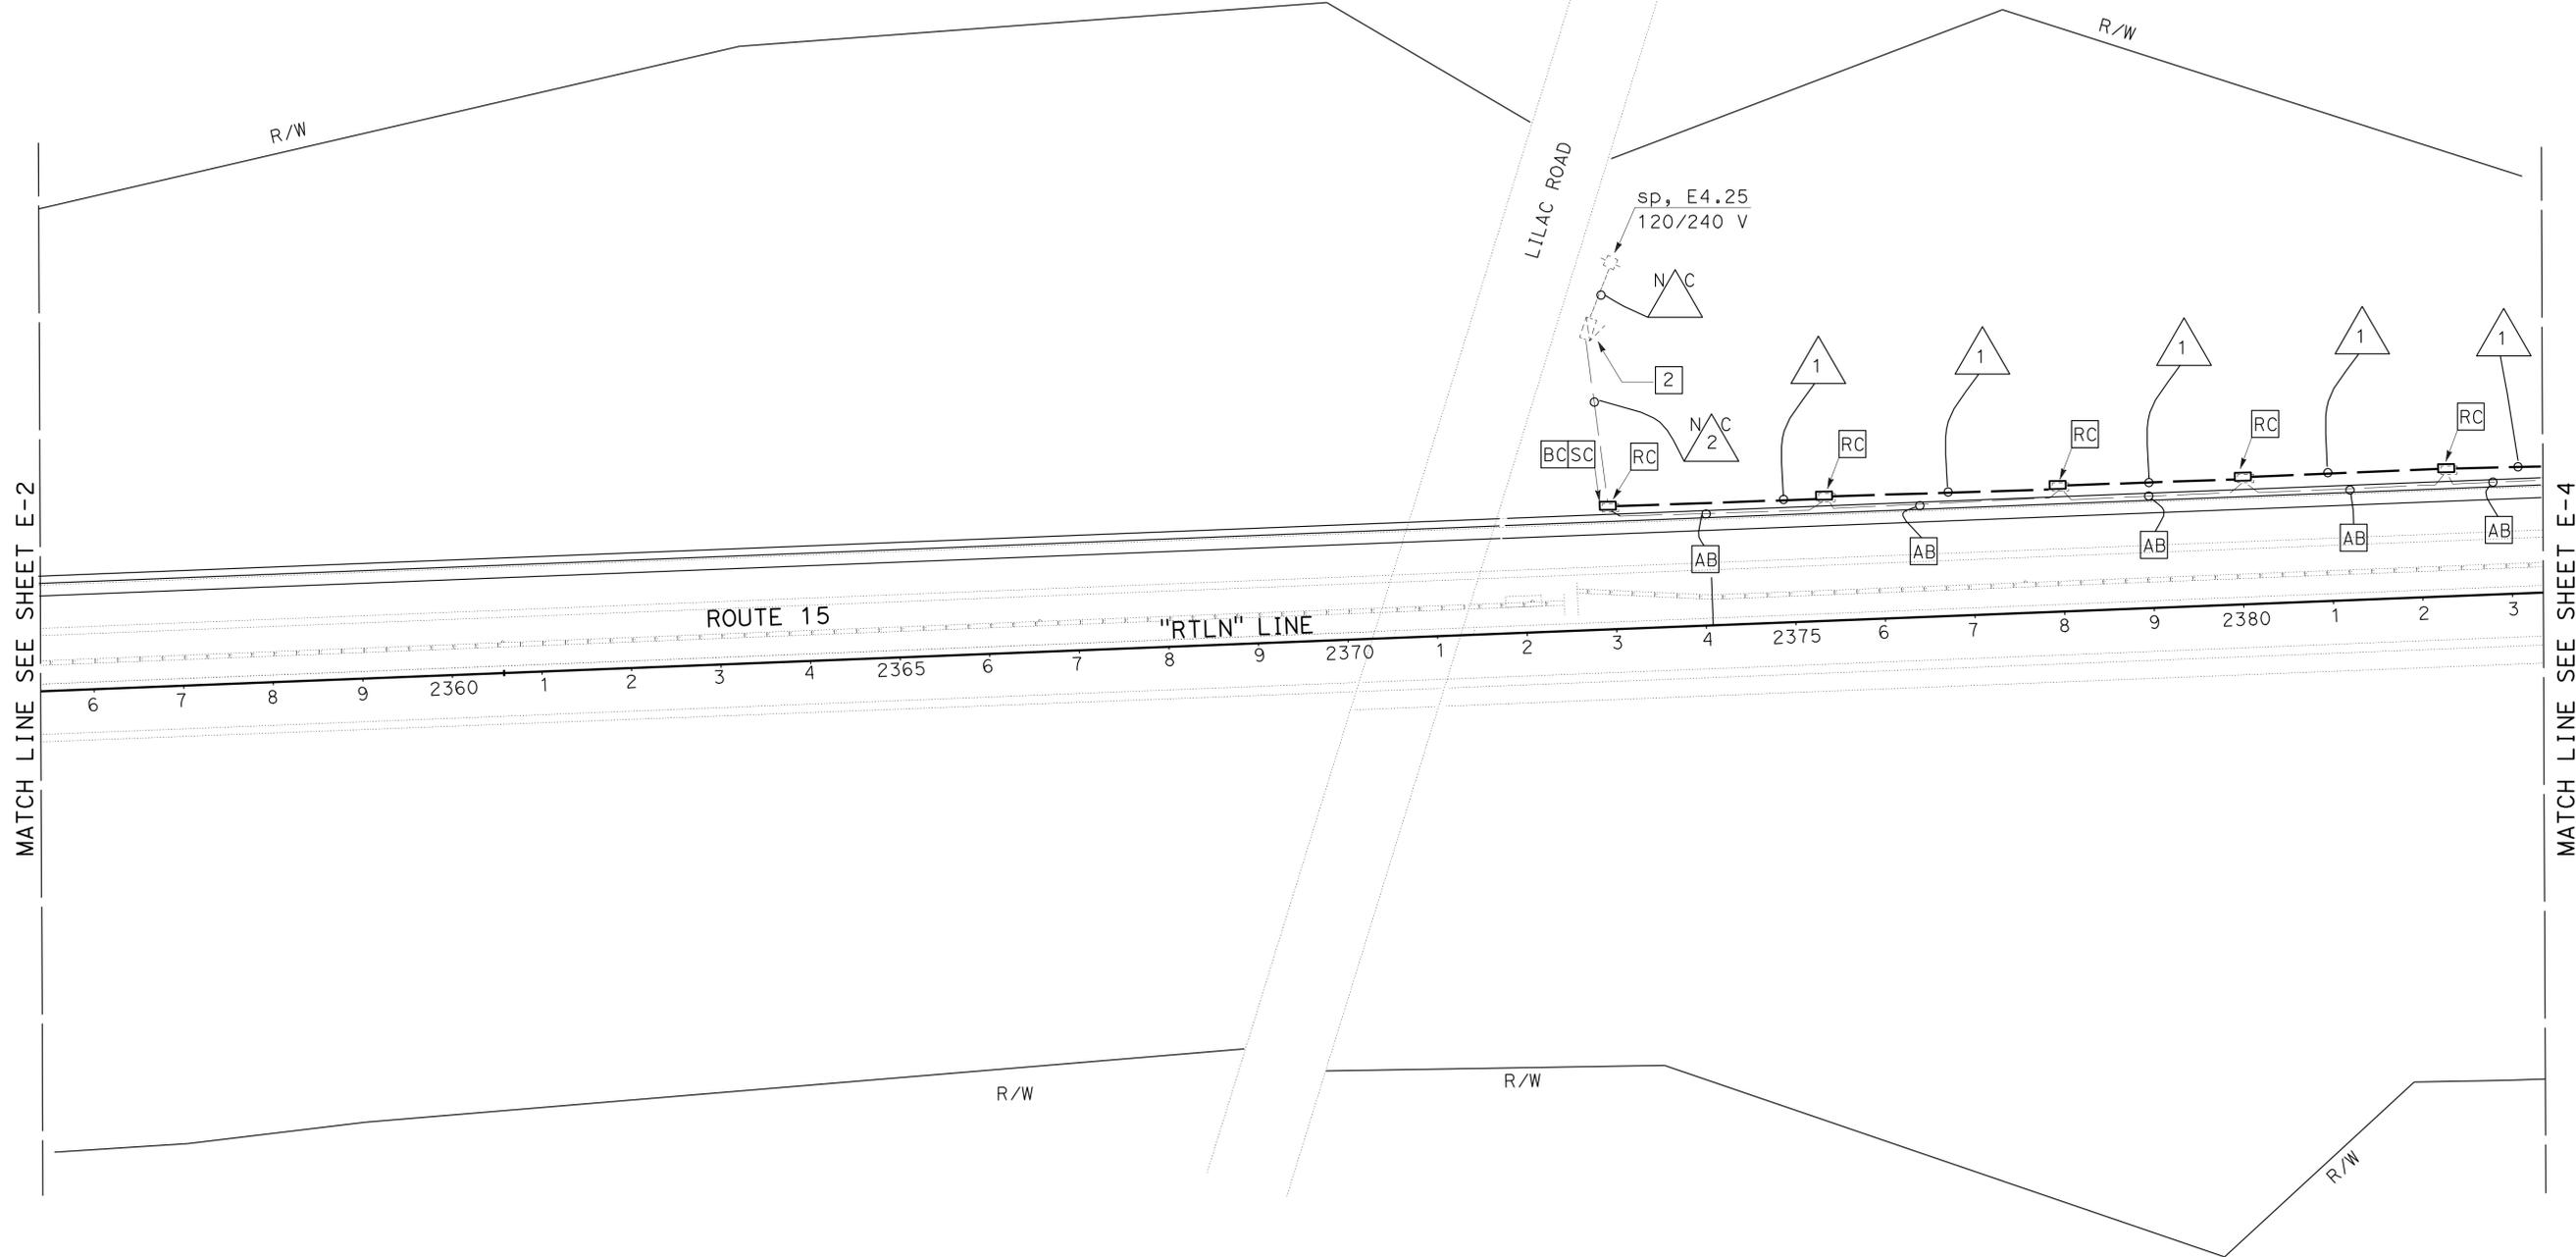
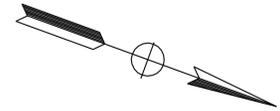
**NOTES (TSO):**

- 1 - EXISTING LIGHTING AND SIGN ILLUMINATION SYSTEM PARTIALLY SHOWN.
- 2 - SD 120/240 VOLTS, MAIN 2P-70 AMP 2P-40 AMP (sign), 2P-30 AMP (SPARE).
- 3 - NEW PULL BOXES SHALL BE No. 5 NON-PCC TYPE.

FOR ACCURATE RIGHT OF WAY AND ACCESS DATA, CONTACT RIGHT OF WAY ENGINEERING AT THE DISTRICT OFFICE.

**CONDUIT NOTES (TSO):**

- △ 1 - 2" C, 2#2 (SIGN)
- △ 2 - EXISTING 2" C, 2#2 (SIGN)



MATCH LINE SEE SHEET E-2

MATCH LINE SEE SHEET E-4

STATE OF CALIFORNIA - DEPARTMENT OF TRANSPORTATION	FUNCTIONAL SUPERVISOR	DALE WILSON
<b>Caltrans</b> TRAFFIC ELECTRICAL	CALCULATED/DESIGNED BY	CHECKED BY
	FARIBA RAMOS	ENRIQUE BERNAL
	REVISOR BY	DATE REVISED

THIS PLAN IS ACCURATE FOR ELECTRICAL WORK ONLY.

**LIGHTING AND SIGN ILLUMINATION**

SCALE: 1"=100'

**E-3**

LAST REVISION DATE PLOTTED => 01-NOV-2010 10-20-10 TIME PLOTTED => 14:36

Dist	COUNTY	ROUTE	POST MILES TOTAL PROJECT	SHEET No.	TOTAL SHEETS
11	SD	15	R42.5/R45.9	32	46

*Fariba Ramos* 09-08-10  
 REGISTERED CIVIL ENGINEER DATE  
 10-04-10  
 PLANS APPROVAL DATE

REGISTERED PROFESSIONAL ENGINEER  
 FARIBA RAMOS  
 No. E15619  
 Exp. 12-31-11  
 CIVIL  
 STATE OF CALIFORNIA

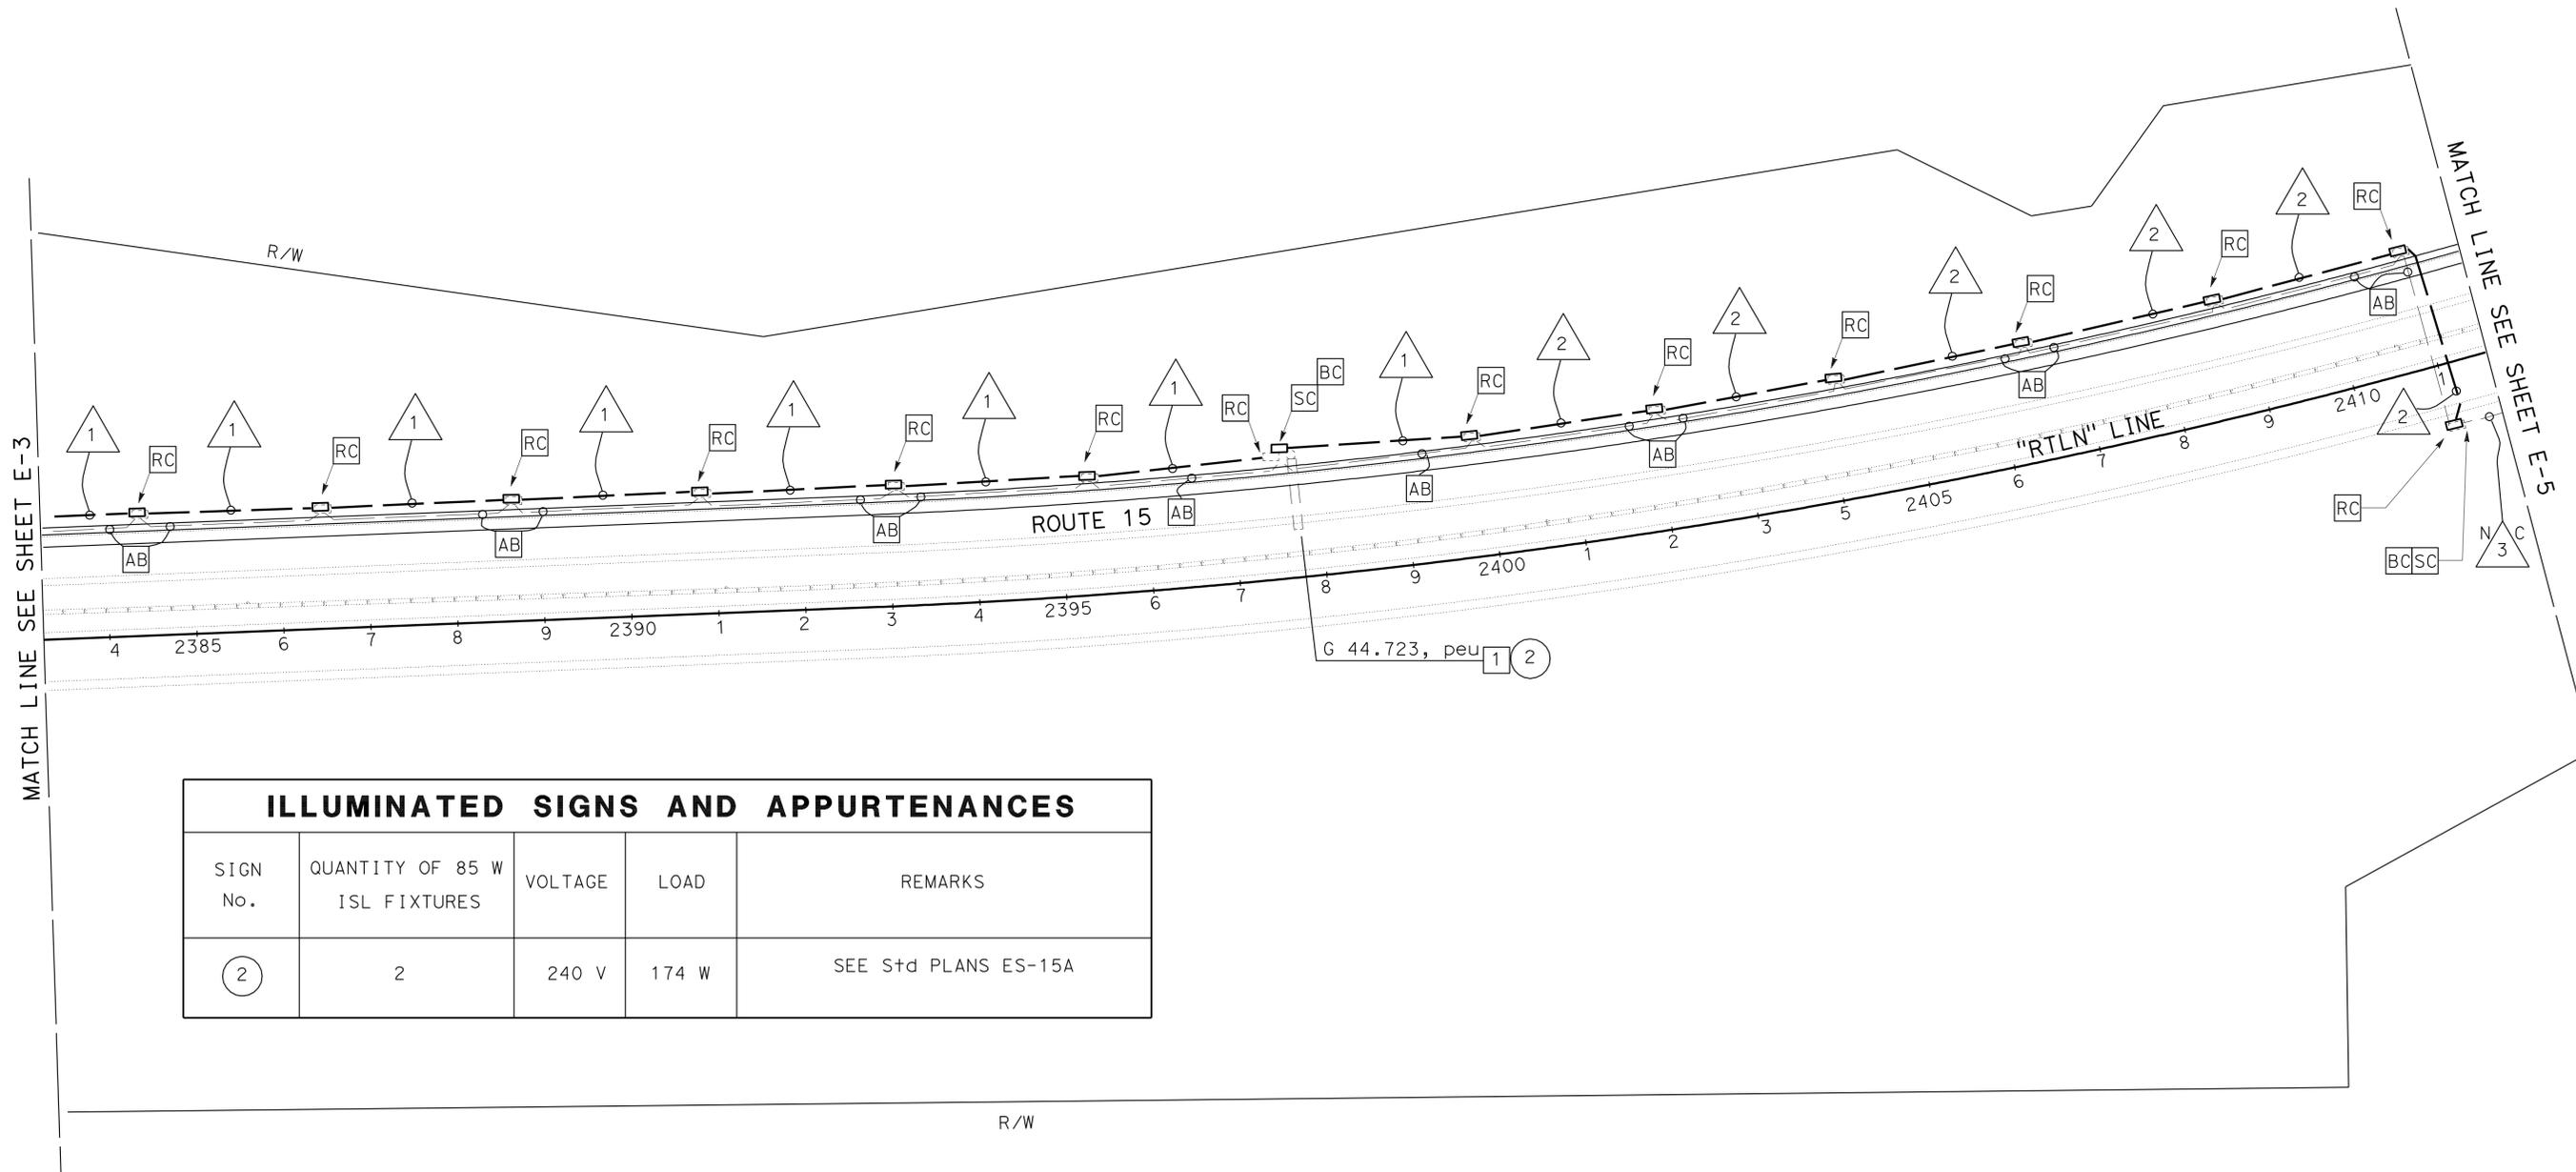
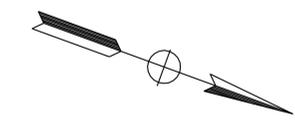
THE STATE OF CALIFORNIA OR ITS OFFICERS OR AGENTS SHALL NOT BE RESPONSIBLE FOR THE ACCURACY OR COMPLETENESS OF SCANNED COPIES OF THIS PLAN SHEET.

**NOTES (TSO):**

- 1 - [RS] SIGN LIGHTING FIXTURES AND SIGN CONTROL.
  - 2 - EXISTING LIGHTING AND SIGN ILLUMINATION SYSTEM PARTIALLY SHOWN.
  - 3 - NEW PULL BOXES SHALL BE No. 5 NON-PCC TYPE.
- FOR ACCURATE RIGHT OF WAY AND ACCESS DATA, CONTACT RIGHT OF WAY ENGINEERING AT THE DISTRICT OFFICE.

**CONDUIT NOTES (TSO):**

- 1 - 2" C, 2#2 (SIGN)
- 2 - 2" C, 2#4 (SIGN)
- $\frac{N}{3} \frac{C}{3}$  - Exist 2" C, 2#4 (SIGN)



**ILLUMINATED SIGNS AND APPURTENANCES**

SIGN No.	QUANTITY OF 85 W ISL FIXTURES	VOLTAGE	LOAD	REMARKS
2	2	240 V	174 W	SEE Std PLANS ES-15A

STATE OF CALIFORNIA - DEPARTMENT OF TRANSPORTATION  
**Caltrans** TRAFFIC ELECTRICAL

FUNCTIONAL SUPERVISOR  
 DALE WILSON

CALCULATED/DESIGNED BY  
 CHECKED BY

FARIBA RAMOS  
 ENRIQUE BERNAL

REVISED BY  
 DATE REVISED

THIS PLAN IS ACCURATE FOR ELECTRICAL WORK ONLY.

**LIGHTING AND SIGN ILLUMINATION**

SCALE: 1"=100'

**E-4**



Dist	COUNTY	ROUTE	POST MILES TOTAL PROJECT	SHEET No.	TOTAL SHEETS
11	SD	15	R42.5/R45.9	33	46

<i>Farib Ramos</i>	09-08-10
REGISTERED CIVIL ENGINEER	DATE
10-04-10	
PLANS APPROVAL DATE	

REGISTERED PROFESSIONAL ENGINEER
FARIBA RAMOS
No. E15619
Exp. 12-31-11
CIVIL
STATE OF CALIFORNIA

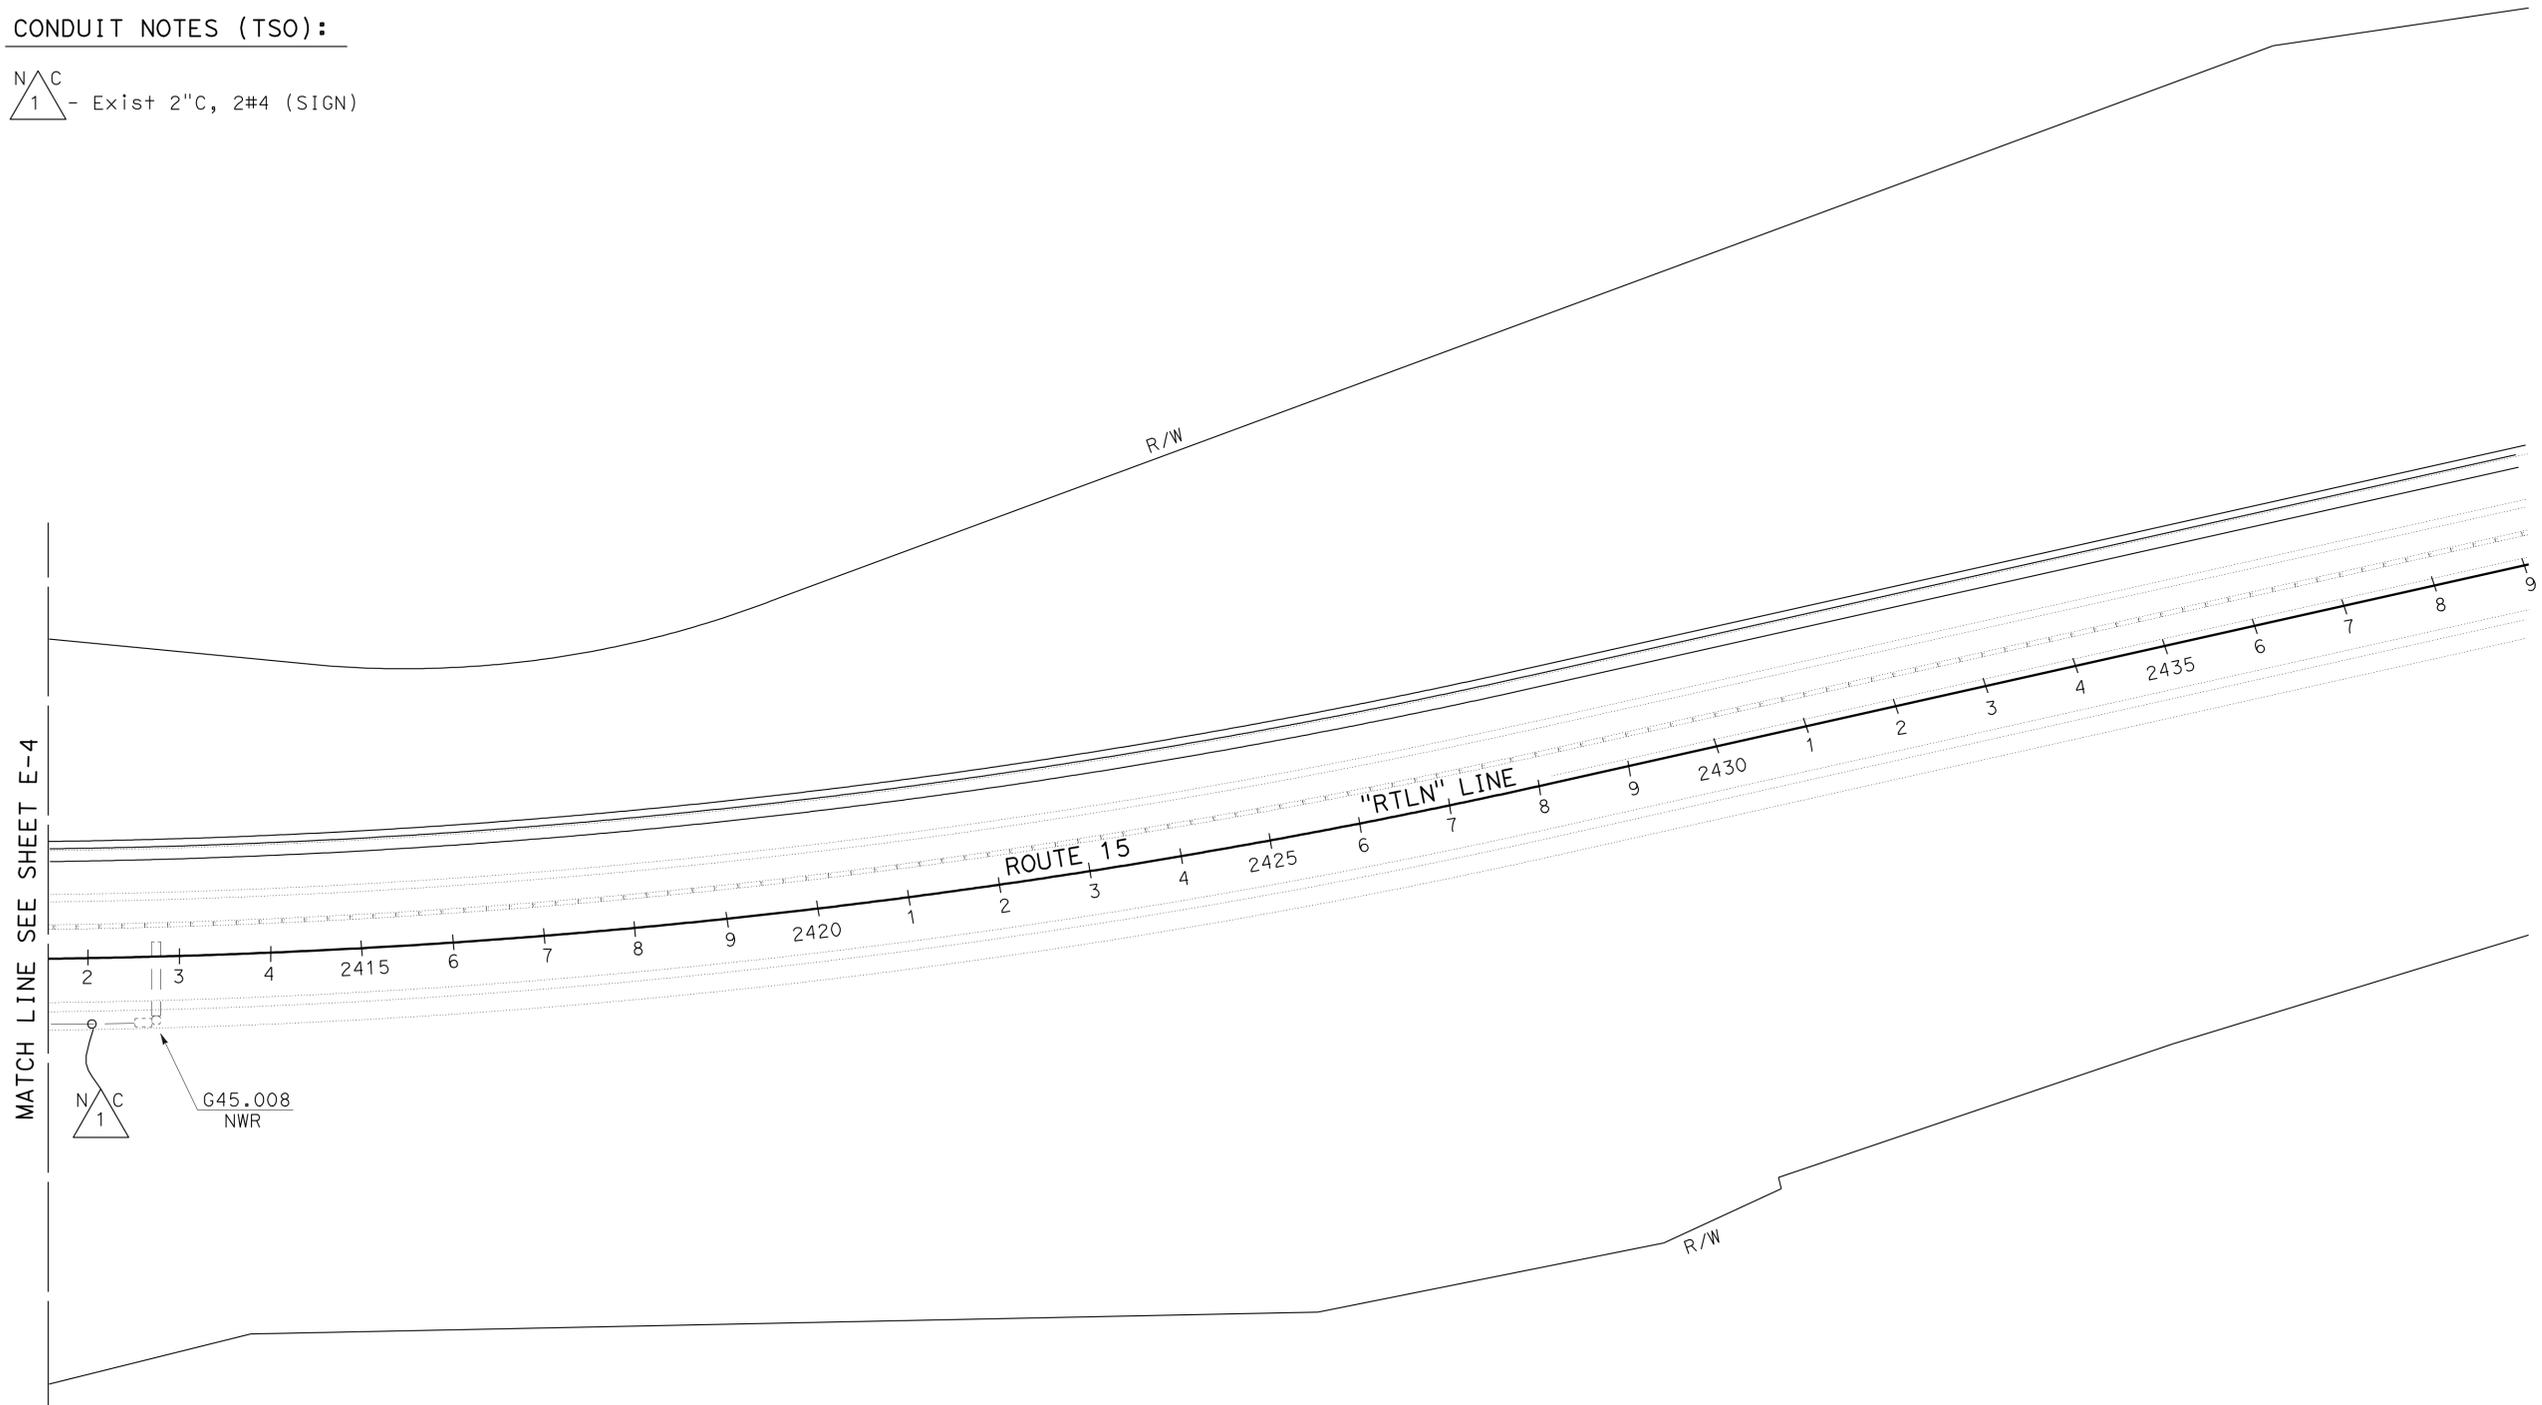
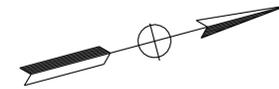
THE STATE OF CALIFORNIA OR ITS OFFICERS OR AGENTS SHALL NOT BE RESPONSIBLE FOR THE ACCURACY OR COMPLETENESS OF SCANNED COPIES OF THIS PLAN SHEET.

**NOTES (TSO):**

1 - EXISTING LIGHTING AND SIGN ILLUMINATION SYSTEM PARTIALLY SHOWN.  
 FOR ACCURATE RIGHT OF WAY AND ACCESS DATA, CONTACT RIGHT OF WAY ENGINEERING AT THE DISTRICT OFFICE.

**CONDUIT NOTES (TSO):**

 - Exist 2"C, 2#4 (SIGN)



MATCH LINE SEE SHEET E-4

 G45.008  
NWR

**LIGHTING AND SIGN ILLUMINATION**

SCALE: 1"=100'

**E-5**

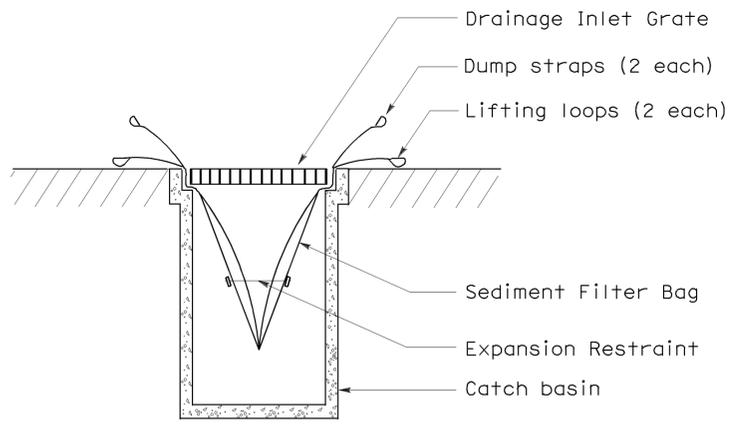
THIS PLAN IS ACCURATE FOR ELECTRICAL WORK ONLY.

STATE OF CALIFORNIA - DEPARTMENT OF TRANSPORTATION	FUNCTIONAL SUPERVISOR	DALE WILSON	CALCULATED/DESIGNED BY	CHECKED BY	FARIBA RAMOS	ENRIQUE BERNAL	REVISOR BY	DATE REVISED
<b>Caltrans</b> TRAFFIC ELECTRICAL								




DIST	COUNTY	ROUTE	POST MILES TOTAL PROJECT	SHEET NO.	TOTAL SHEETS
11	SD	15	R42.5/R45.9	34	46


*Robert B. Schott*  
 LICENSED LANDSCAPE ARCHITECT  
 August 15, 2008  
 PLANS APPROVAL DATE  
The State of California or its officers or agents shall not be responsible for the accuracy or completeness of electronic copies of this plan sheet.



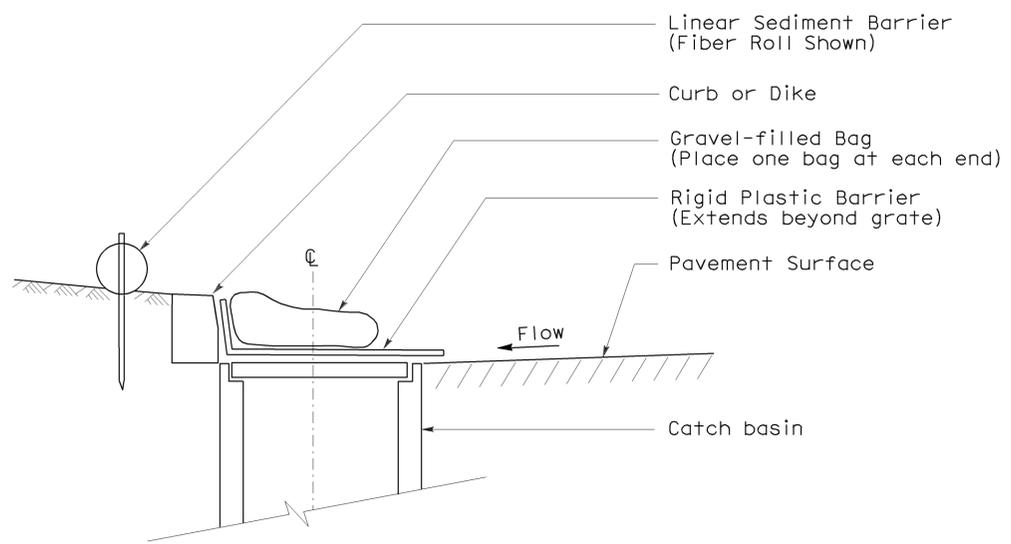
**SECTION B-B**  
**SEDIMENT FILTER BAG DETAIL**



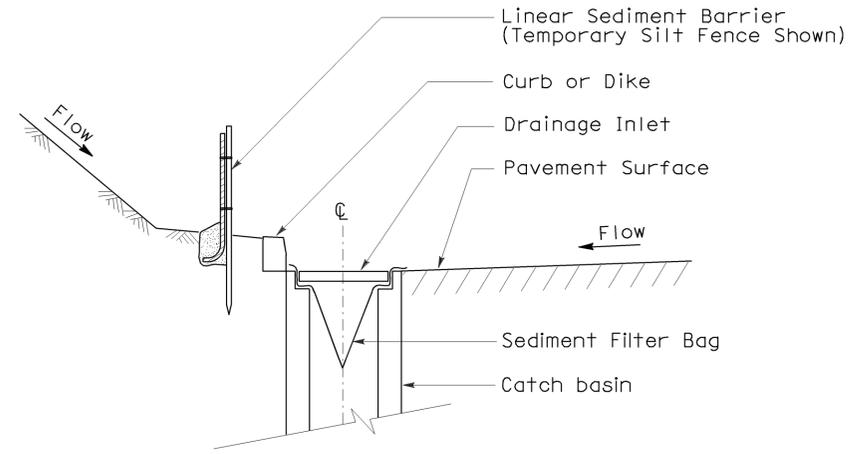
**SECTION**  
**TEMPORARY DRAINAGE INLET PROTECTION (TYPE 6A)**  
**(CATCH BASIN WITH GRATE)**



**SECTION A-A**

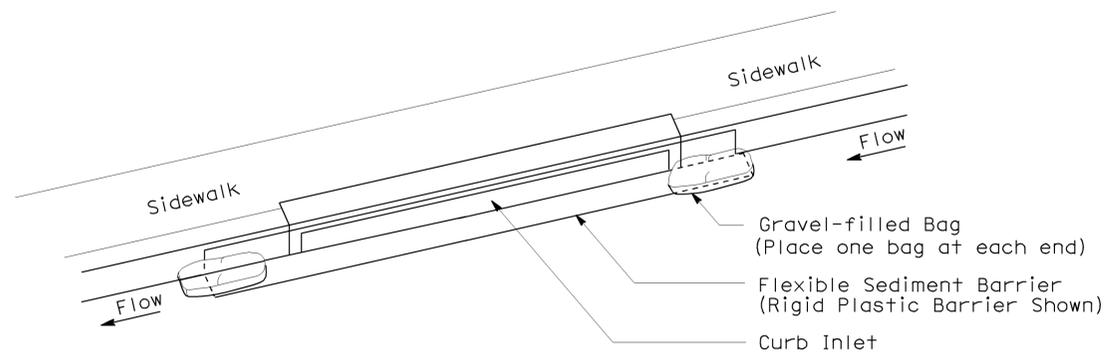

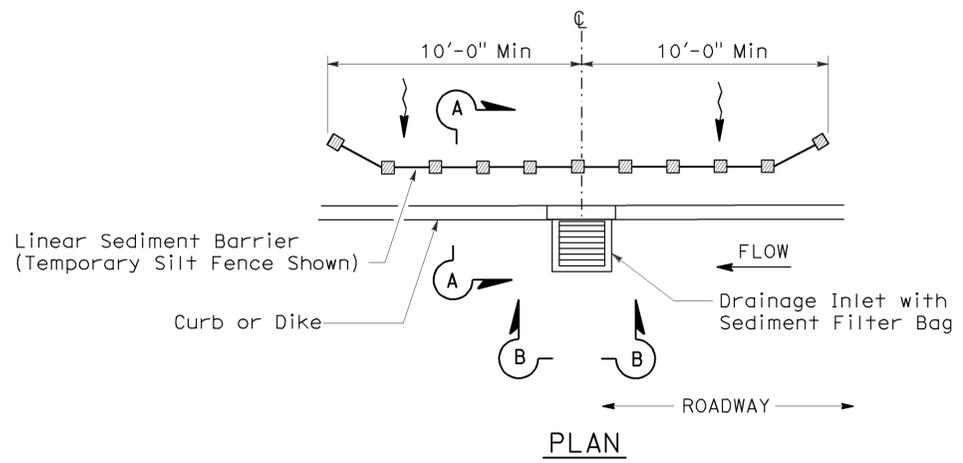**PERSPECTIVE**  
**TEMPORARY DRAINAGE INLET PROTECTION (TYPE 6B)**  
**(CURB INLET WITHOUT GRATE)**



**PLAN**  
**TEMPORARY DRAINAGE INLET PROTECTION (TYPE 5)**  
**(SEDIMENT FILTER BAG)**

**NOTES:**

1. See Standard Plan T51 for Temporary Silt Fence.
2. Dimensions may vary to fit field conditions.

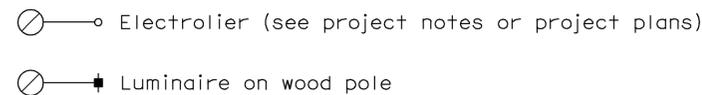
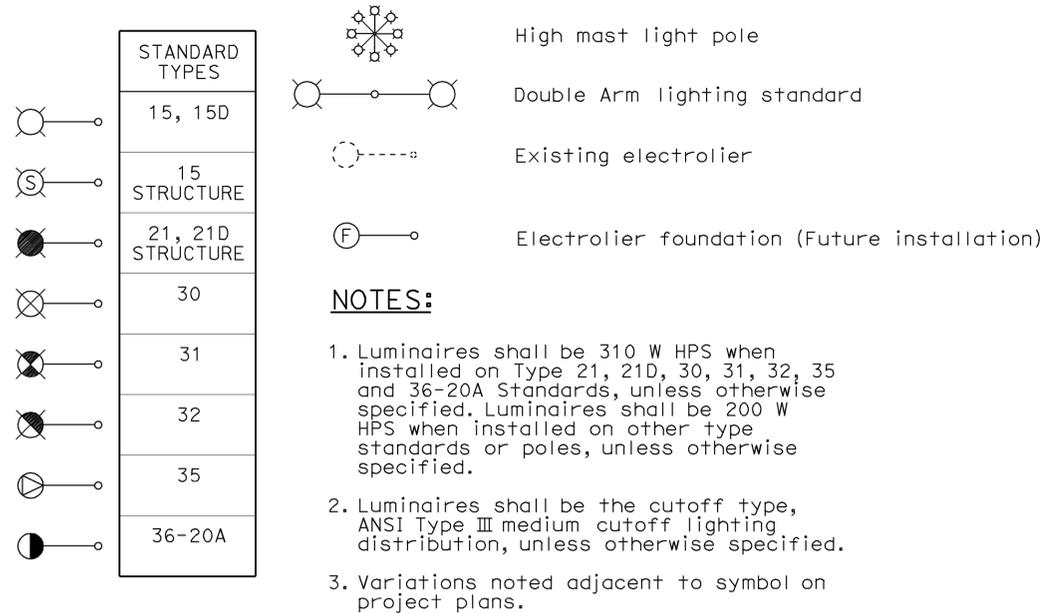
To accompany plans dated 10-04-10

STATE OF CALIFORNIA  
DEPARTMENT OF TRANSPORTATION  
**TEMPORARY WATER POLLUTION CONTROL DETAILS**  
**(TEMPORARY DRAINAGE INLET PROTECTION)**

NO SCALE  
NSP T64 DATED AUGUST 15, 2008 SUPPLEMENTS  
THE STANDARD PLANS BOOK DATED MAY 2006.

2006 NEW STANDARD PLAN NSP T64

# ELECTROLIERS



## STANDARD NOTES:

- AB** Abandon. If applied to conduit, remove conductors.
- BC** Install pull box in existing conduit run.
- BP** Pedestrian barricade, type as indicated on plan.
- CB** Install conduit into existing pull box.
- CC** Connect new and existing conduit. Remove existing conductors and install conductors as indicated.
- CF** Conduit to remain for future use. Remove conductors. Install pull wire or rope.
- DH** Detector handhole.
- FA** Foundation to be abandoned.
- IS** Install sign on signal mast arm.
- NS** No slip base on standard.
- PEC** Photoelectric control.
- PEU** Photoelectric unit.
- RC** Equipment or material to be removed and become the property of the Contractor.
- RE** Remove electrolier, fuses and ballast. Tape ends of conductors.
- RL** Relocate equipment.
- RR** Remove and reuse equipment.
- RS** Remove and salvage equipment.
- SC** Splice new to existing conductors.
- SD** Service disconnect.
- SF** Standard to remain for future use. Remove luminaire, pole conductors, fuses and ballast.
- TSP** Telephone service point.

# ABBREVIATIONS AND EQUIPMENT DESIGNATIONS

## PROPOSED EXISTING

BBS	bbs	Battery backup system
BC	bc	Bolt circle
C	C	Conduit
CCTV	cctv	Closed circuit television
CKT	ckt	Circuit
CMS	cms	Changeable message sign
DLC	dlc	Loop detector lead-in cable
EMS	ems	Extinguishable message sign
EVC	evc	Emergency vehicle cable
EVD	evd	Emergency vehicle detector
FB	fb	Flashing beacon
FBCA	fbca	Flashing beacon control assembly
FBS	fbs	Flashing beacon with slip base
FO	fo	Fiber optic
G	G	Ground (Equipment Grounding Conductor)
GFCI	GFCI	Ground fault circuit interrupt
HAR	har	Highway advisory radio
HEX	hex	Hexagonal
HPS	hps	High pressure sodium
IISNS	iisns	Internally illuminated street name sign
ISL	isl	Induction sign lighting
LED	led	Light emitting diode
LMA	lma	Luminaire mast arm
LPS	lps	Low pressure sodium
LTG	ltg	Lighting
LUM	lum	Luminaire
MAT	mat	Mast arm mounting vehicle signal faces, top attachment
MAS	mas	Mast arm mounting vehicle signal faces, side attachment
MAS-4A	mas-4A	Mast arm mounting vehicle signal faces, side attachment - 4 signal section
MAS-4B	mas-4B	
MAS-4C	mas-4C	
MAS-5A	mas-5A	Mast arm mounting vehicle signal faces, side attachment - 5 signal section
MAS-5B	mas-5B	
MC	mc	Mercury contactor
M/M	m/m	Multiple to multiple transformer
MT	mt	Conduit with pull wire or rope only
MTG	mtg	Mounting
	mv	Mercury vapor lighting fixture
N	N	Neutral (Grounded Conductor)
NC	NC	Normally closed
NO	NO	Normally open
PB	pb	Pull box
PEC	pec	Photoelectric control (Type I, II, III, IV or V as shown)
PED	ped	Pedestrian
PEU	peu	Photoelectric unit
PPB	ppb	Pedestrian push button
RL		Relocated equipment
RM	rm	Ramp metering
SB	sb	Slip base
SIC	sic	Signal interconnect cable
SIG	sig	Signal
SMA	sma	Signal mast arm
SNS	sns	Street name sign
SP	sp	Service point
TDC	tdc	Telephone demarcation cabinet
TMS	tms	Traffic monitoring station
TOS	tos	Traffic Operations System
VEH	veh	Vehicle
XFMR	xfmr	Transformer
COMM	comm	Communication
RWIS	rwis	Roadway weather information system

DIST	COUNTY	ROUTE	POST MILES TOTAL PROJECT	SHEET NO.	TOTAL SHEETS
11	SD	15	R42.5/R45.9	35	46

*Jeffrey G. McRae*  
REGISTERED ELECTRICAL ENGINEER

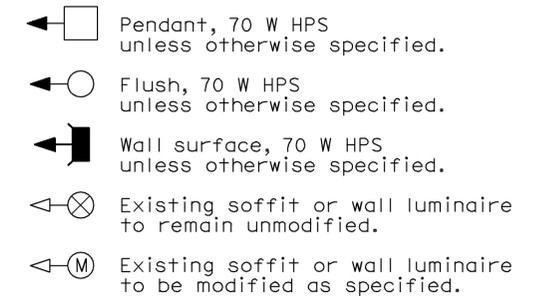
October 5, 2007  
PLANS APPROVAL DATE

Jeffrey G. McRae  
No. E14512  
Exp. 6-30-08  
ELECTRICAL  
STATE OF CALIFORNIA

The State of California or its officers or agents shall not be responsible for the accuracy or completeness of electronic copies of this plan sheet.

To accompany plans dated 10-04-10

## SOFFIT AND WALL MOUNTED LUMINAIRES



### NOTE:

Arrow indicates "street side" of luminaire.

STATE OF CALIFORNIA  
DEPARTMENT OF TRANSPORTATION

## ELECTRICAL SYSTEMS (SYMBOLS AND ABBREVIATIONS)

NO SCALE

RSP ES-1A DATED OCTOBER 5, 2007 SUPERSEDES STANDARD PLAN ES-1A DATED MAY 1, 2006 - PAGE 400 OF THE STANDARD PLANS BOOK DATED MAY 2006.

**REVISED STANDARD PLAN RSP ES-1A**

2006 REVISED STANDARD PLAN RSP ES-1A

DIST	COUNTY	ROUTE	POST MILES TOTAL PROJECT	SHEET NO.	TOTAL SHEETS
11	SD	15	R42.5/R45.9	36	46

*Jeffery G. McRae*  
 REGISTERED ELECTRICAL ENGINEER  
 October 5, 2007  
 PLANS APPROVAL DATE  
 The State of California or its officers or agents shall not be responsible for the accuracy or completeness of electronic copies of this plan sheet.

REGISTERED PROFESSIONAL ENGINEER  
 Jeffrey G. McRae  
 No. E14512  
 Exp. 6-30-08  
 ELECTRICAL  
 STATE OF CALIFORNIA

### CONDUIT

PROPOSED	EXISTING	
---	---	Lighting Conduit, unless otherwise indicated or noted
---	---	Traffic signal conduit
-C-	-c-	Communication conduit
-T-	-t-	Telephone conduit
-F-	-f-	Fire alarm conduit
-FO-	-fo-	Fiber optic conduit
---	---	Conduit termination
		Conduit riser in/on structure or service pole

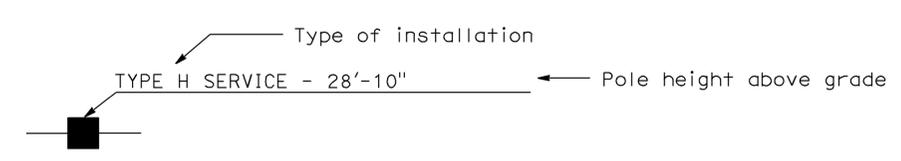
### SIGNAL EQUIPMENT

PROPOSED	EXISTING	
		Pedestrian signal face
		Pedestrian push button post
		Pedestrian barricade
		Vehicle signal face (with backplate, 3-Section: red, yellow and green)
		Vehicle signal face with angle visors
		Modifications of basic symbols: "L" Indicates all non-arrow sections lowered "LG" Indicates lowered green section only "PV" Indicates 12" programmed visibility sections "8" indicates all 8" sections (only when specified)
		Type 15TS and Vehicle signal face
		Vehicle signal face with red, yellow and green left arrow sections
		Vehicle signal face with red and yellow sections and up green arrow
		Vehicle signal face (5 Section) with red, yellow and green sections and yellow and green right arrows
		Type 1 Standard and attached vehicle signal faces
		Standard with signal mast arm only and attached vehicle signal faces and internally illuminated street name sign
		Type 33 Standard, Left-turn vehicle signal face and sign
		Standard with luminaire and signal mast arms and attached vehicle signal faces
		Cantilever flashing beacon, Type 9 Frame, with a sign unless otherwise specified or indicated
		Type 15-FBS Standard with two vehicle signal face sections with lens, backplate and visor with a sign
		Flashing beacon. One vehicle signal face section with lens, backplate and visor. "R" indicates red indication, "Y" indicates yellow indication
		Controller assembly. Door indicates front of cabinet

### SERVICE EQUIPMENT

PROPOSED	EXISTING	
---OH---	---oh---	Overhead lines
		Wood pole "U" indicates utility owned
		Pole guy with anchor
		Utility transformer - ground mounted
		Service equipment enclosure type
		Service equipment enclosure door indicates front of enclosure
		Telephone demarcation cabinet

### POLE-MOUNTED SERVICE DESIGNATION



### ILLUMINATED OVERHEAD SIGN

PROPOSED	EXISTING	
		Overhead sign - Single post
		Overhead sign - Two post
		Overhead sign - Mounted on structure
		Overhead sign with electrolier

### SIGNAL EQUIPMENT Cont

PROPOSED	EXISTING	
		Guard post
		Type 1 Standard with "Meter On" sign
		Emergency Vehicle detector

### NOTES:

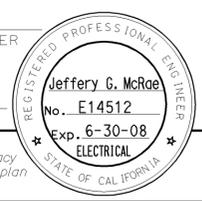
- All signal sections shall be 12" unless shown otherwise.
- Signal heads shall be provided with backplates unless shown otherwise.
- Signal indication shall be LED.

STATE OF CALIFORNIA  
 DEPARTMENT OF TRANSPORTATION  
**ELECTRICAL SYSTEMS  
 (SYMBOLS AND ABBREVIATIONS)**  
 NO SCALE

RSP ES-1B DATED OCTOBER 5, 2007 SUPERCEDES STANDARD PLAN ES-1B  
 DATED MAY 1, 2006 - PAGE 401 OF THE STANDARD PLANS BOOK DATED MAY 2006.

**REVISED STANDARD PLAN RSP ES-1B**


2006 REVISED STANDARD PLAN RSP ES-1B




To accompany plans dated 10-04-10

### EQUIPMENT IDENTIFICATION

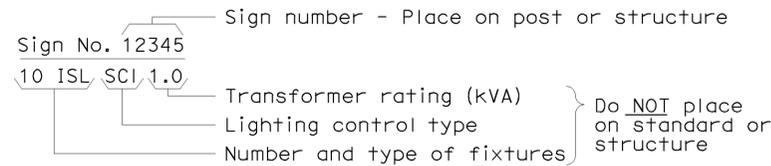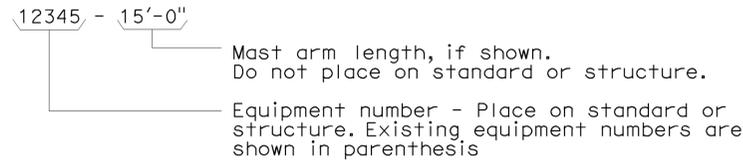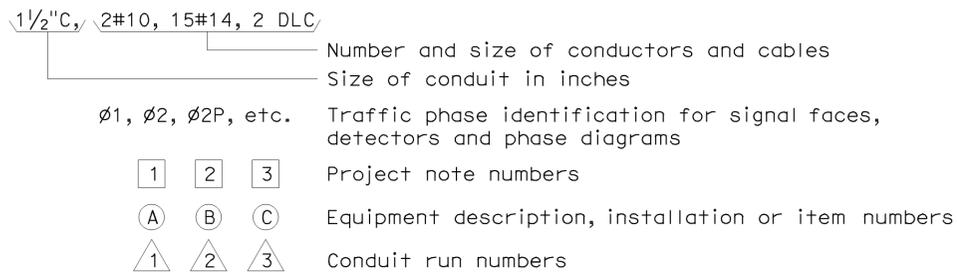
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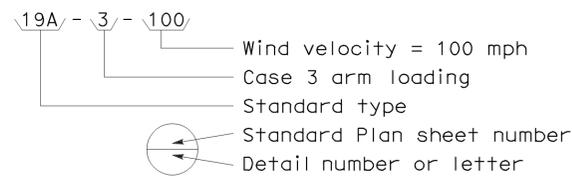
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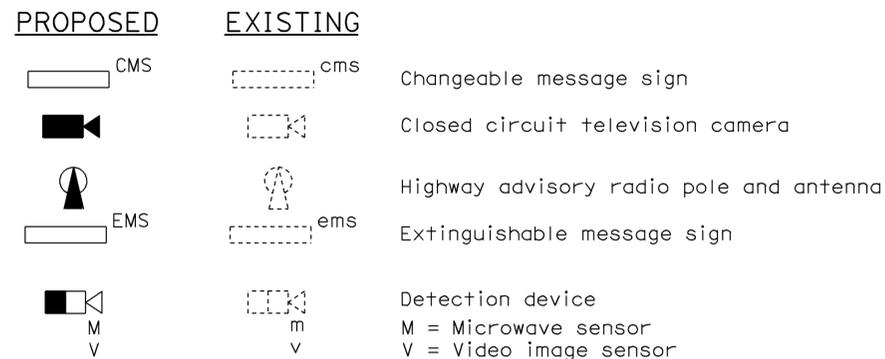
#### CONDUIT AND CONDUCTOR IDENTIFICATION:




#### SIGNAL AND LIGHTING STANDARD (TYPICAL DESIGNATION):




### MISCELLANEOUS EQUIPMENT



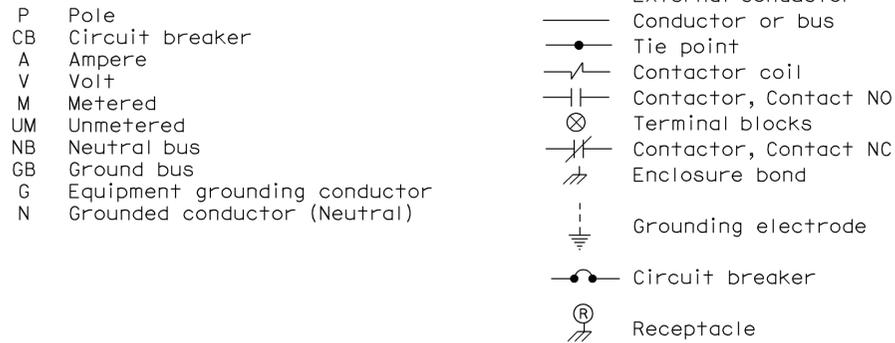
### WIRING DIAGRAM LEGEND



### PULL BOXES

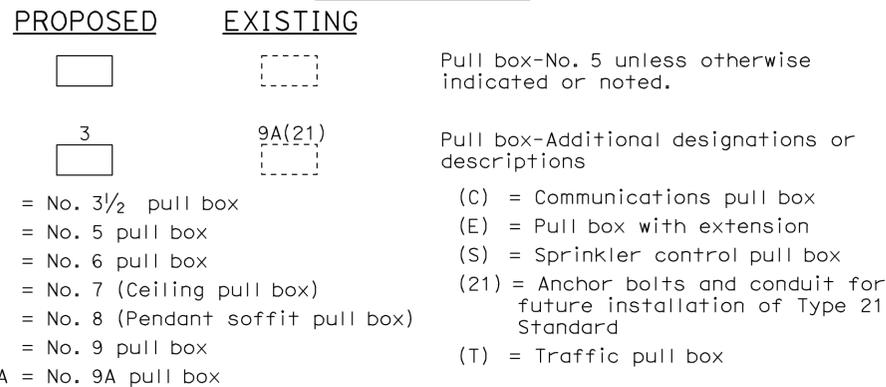

### VEHICLE DETECTORS

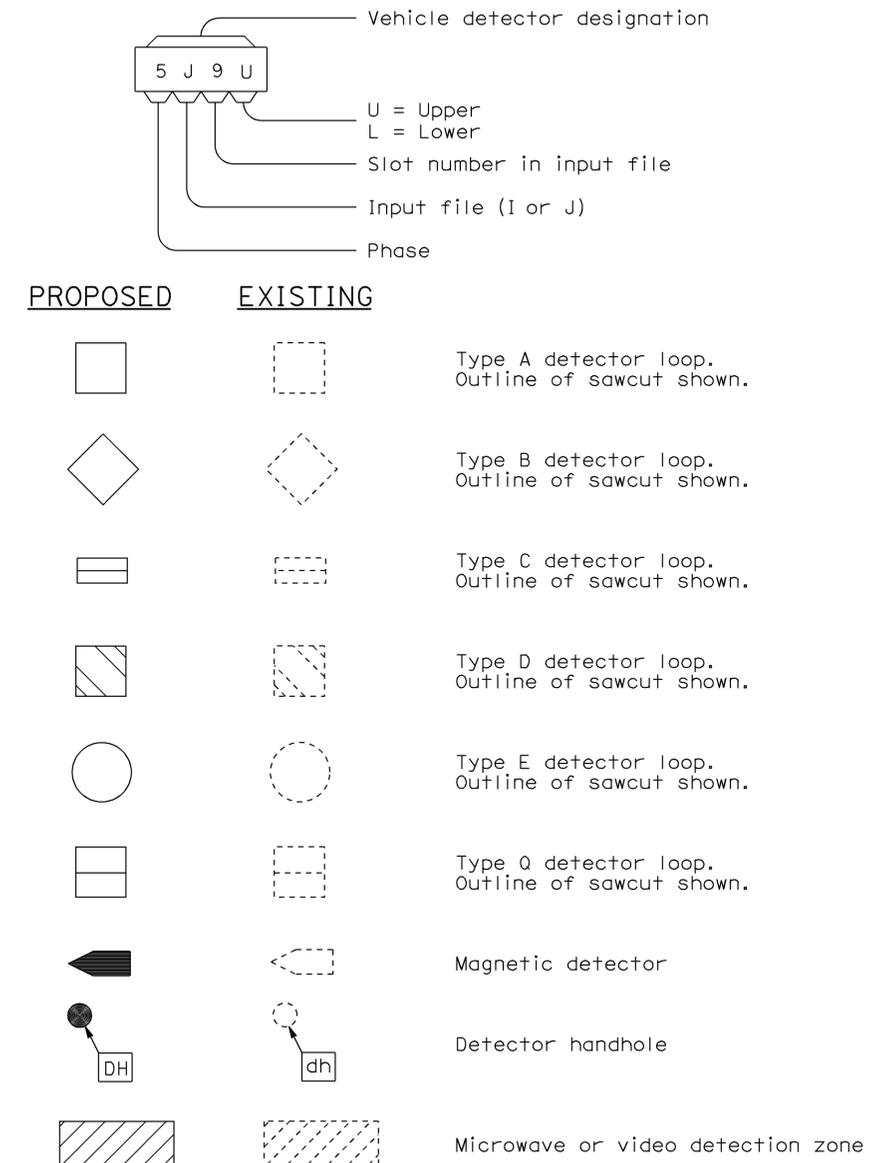

STATE OF CALIFORNIA  
DEPARTMENT OF TRANSPORTATION

## ELECTRICAL SYSTEMS (SYMBOLS AND ABBREVIATIONS)

NO SCALE

RSP ES-1C DATED OCTOBER 5, 2007 SUPERCEDES STANDARD PLAN ES-1C  
DATED MAY 1, 2006 - PAGE 402 OF THE STANDARD PLANS BOOK DATED MAY 2006.

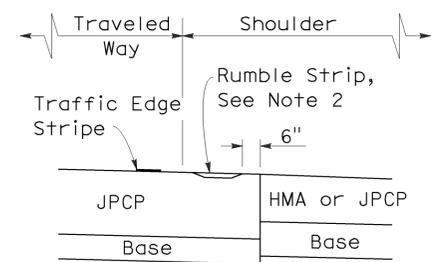
DIST	COUNTY	ROUTE	POST MILES TOTAL PROJECT	SHEET NO.	TOTAL SHEETS
11	SD	15	R42.5/R45.9	38	46

William K. Farnbach  
 REGISTERED CIVIL ENGINEER  
 June 5, 2009  
 PLANS APPROVAL DATE  
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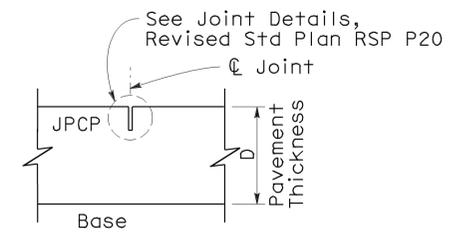
REGISTERED PROFESSIONAL ENGINEER  
 William K. Farnbach  
 No. C49042  
 Exp. 9-30-10  
 CIVIL  
 STATE OF CALIFORNIA

To accompany plans dated 10-04-10

- NOTES:**
- Transverse joints shall be constructed at right angles to the longitudinal pavement joints in new Jointed Plain Concrete Pavement and spaced at successive repeated intervals of 12', 15', 13' and 14'.
  - For locations of rumble strips, see project plans. For rumble strip details not shown, see Standard Plans A40A and A40B.
  - Joint spacing patterns do not apply to intersections.



DETAIL "A"



SECTION C-C  
TRANSVERSE/LONGITUDINAL JOINT  
(no dowel bars/tie bars)


STATE OF CALIFORNIA  
DEPARTMENT OF TRANSPORTATION

**JOINTED PLAIN CONCRETE PAVEMENT-WIDENED SLAB DETAILS**

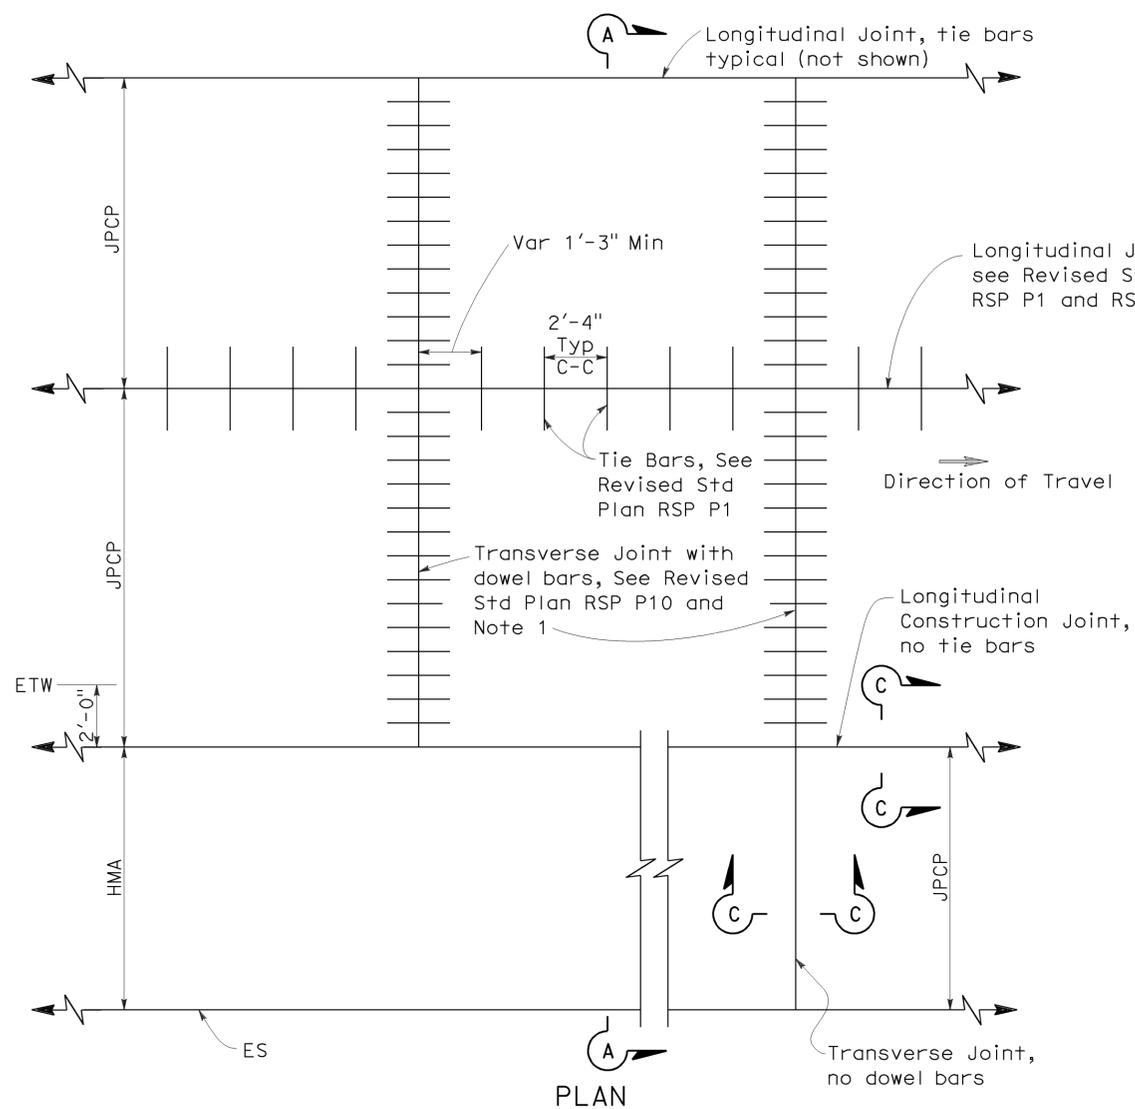
NO SCALE

RSP P2 DATED JUNE 5, 2009 SUPERCEDES STANDARD PLAN P2  
DATED MAY 1, 2006 - PAGE 120 OF THE STANDARD PLANS BOOK DATED MAY 2006.


**REVISED STANDARD PLAN RSP P2**



PLAN  
NEW CONSTRUCTION

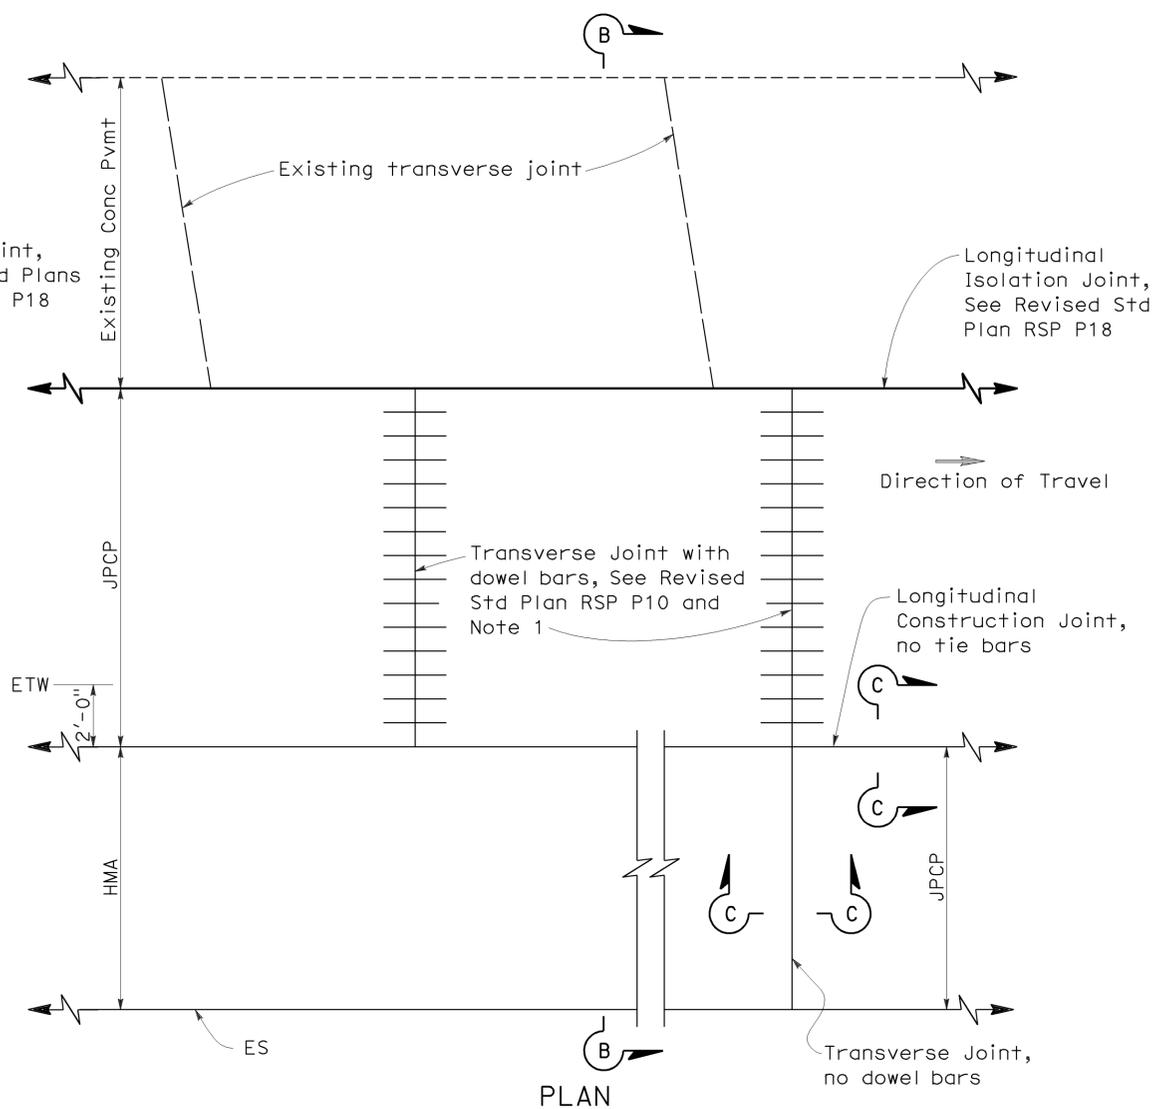


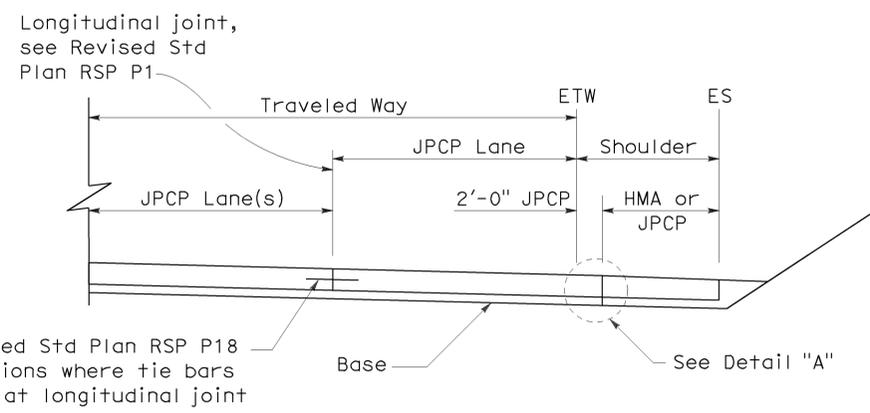PLAN  
LANE/SHOULDER ADDITION OR RECONSTRUCTION



SECTION A-A






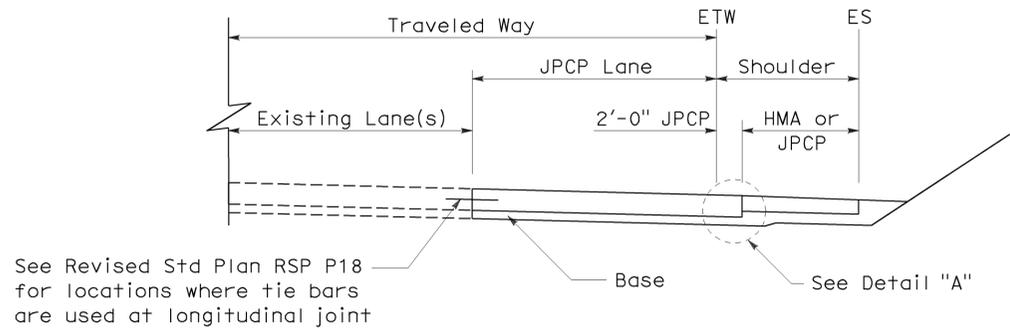
See Revised Std Plan RSP P18 for locations where tie bars are used at longitudinal joint



SECTION B-B

See Revised Std Plan RSP P18 for locations where tie bars are used at longitudinal joint

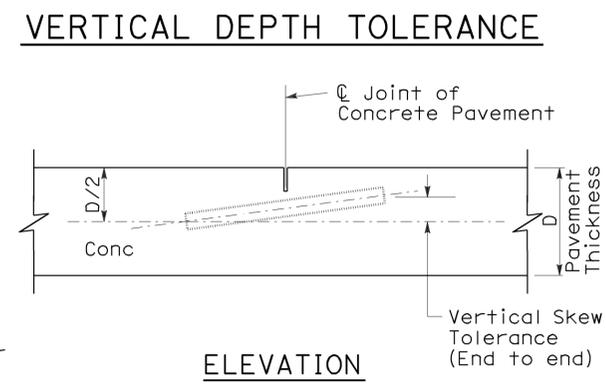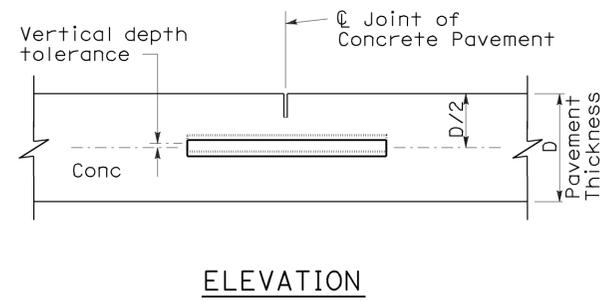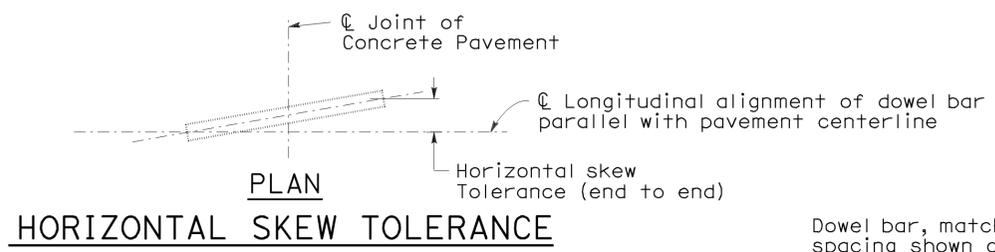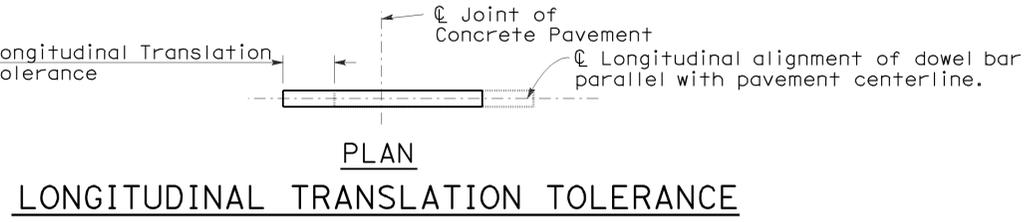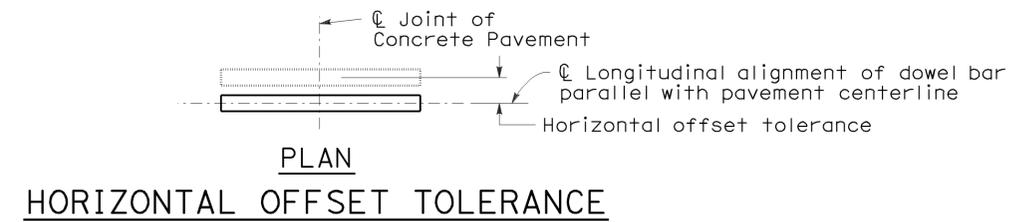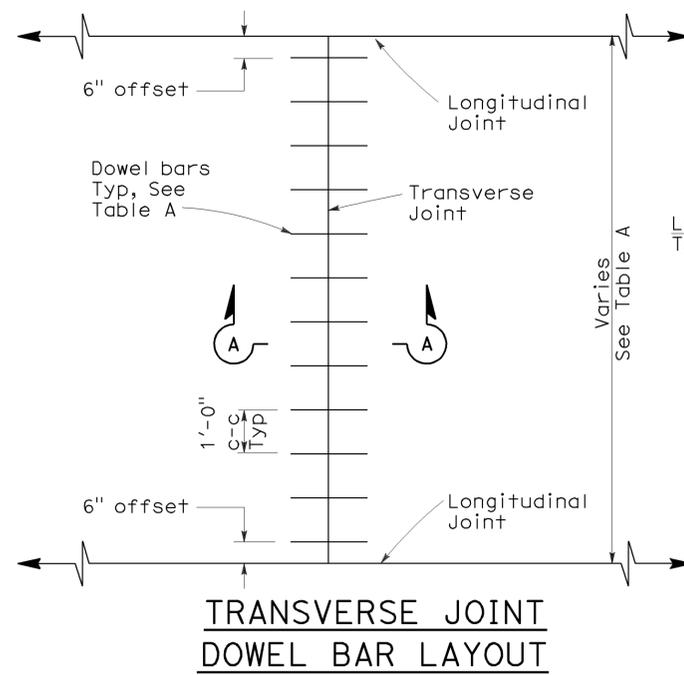2006 REVISED STANDARD PLAN RSP P2






- To accompany plans dated 10-04-10
- NOTES:**
- See Revised Standard Plan RSP P1 for typical dowel bar placement and locations.
  - 1/2" Dia smooth dowel bars are to be used with a pavement thickness, D, equal to or greater than 0.70 feet. For pavement thickness, D, less than 0.70 feet, use 1/4" Dia smooth dowel bars.
  - For widths not shown, see Project Plans.
  - If fresh concrete pavement is placed adjacent to existing concrete pavement, the top corner of the existing concrete pavement does not need to be rounded to the 1/4" radius, as shown.

TABLE A (See Note 3)

Dowel Bar Transverse Spacing Table



Width between Longitudinal Joints	Number of Dowels between Longitudinal Joints
14'-0"	14
13'-0"	13
12'-0"	12
11'-0"	11
10'-0"	10
8'-0"	8
5'-0"	5
4'-0"	4

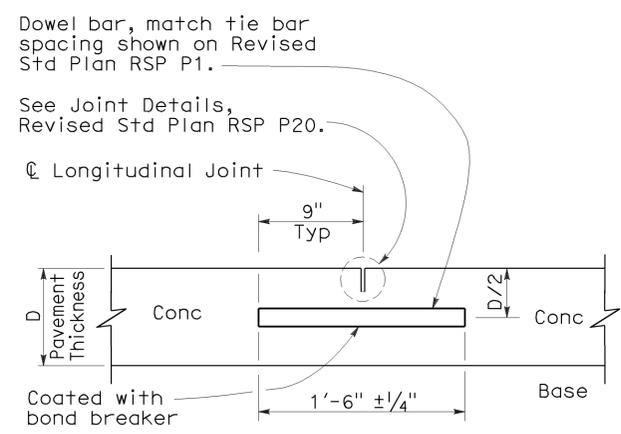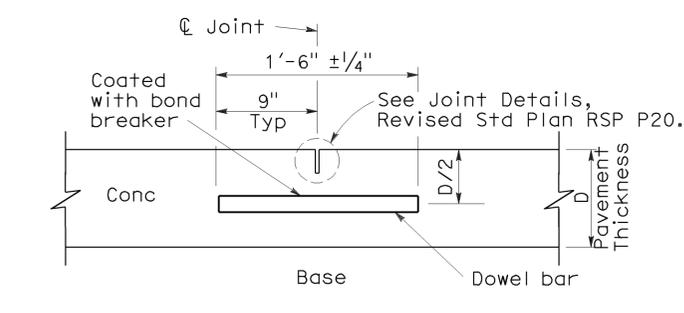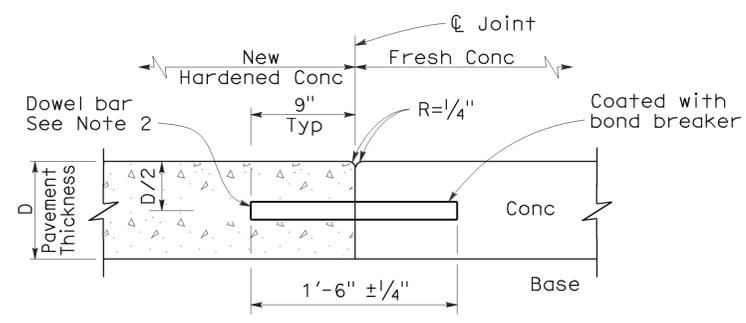

SECTION A-A  
TRANSVERSE  
CONSTRUCTION JOINT DETAIL

TRANSVERSE CONTRACTION JOINT

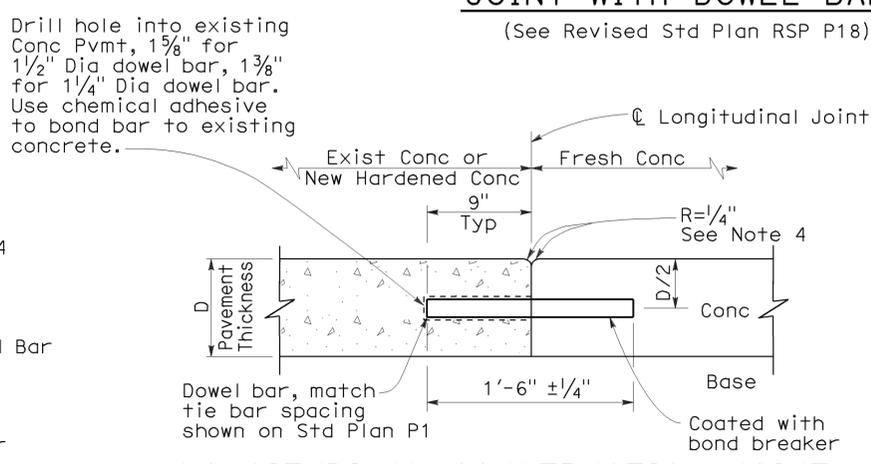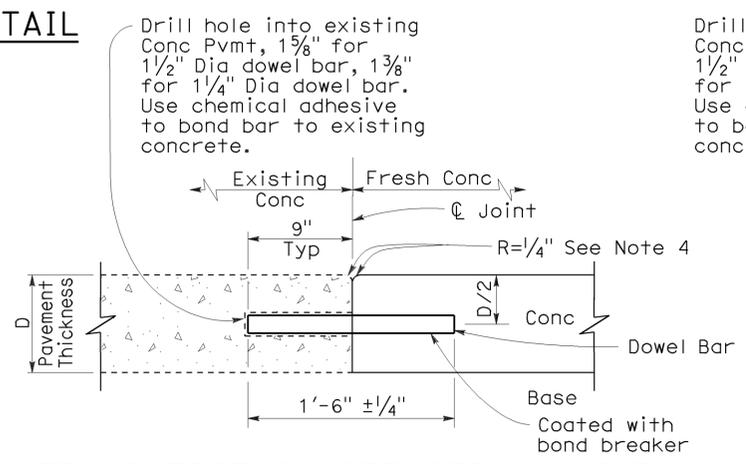LONGITUDINAL CONTRACTION  
JOINT WITH DOWEL BARS  
(See Revised Std Plan RSP P18)



TRANSVERSE CONSTRUCTION JOINT  
FOR EXISTING CONCRETE PAVEMENT  
(Drill and bond locations)

LONGITUDINAL CONSTRUCTION JOINT  
WITH DOWEL BARS  
(See Revised Std Plan RSP P18)

STATE OF CALIFORNIA  
DEPARTMENT OF TRANSPORTATION

**CONCRETE PAVEMENT-  
DOWEL BAR  
DETAILS**  
NO SCALE

RSP P10 DATED MAY 15, 2009 SUPERSEDES STANDARD PLAN P10  
DATED MAY 1, 2006 - PAGE 124 OF THE STANDARD PLANS BOOK DATED MAY 2006.

124


2006 REVISED STANDARD PLAN RSP P10

DIST	COUNTY	ROUTE	POST MILES TOTAL PROJECT	SHEET NO.	TOTAL SHEETS
11	SD	15	R42.5/R45.9	40	46


William K. Farnbach  
 REGISTERED CIVIL ENGINEER  
 May 15, 2009  
 PLANS APPROVAL DATE  
 The State of California or its officers or agents shall not be responsible for the accuracy or completeness of electronic copies of this plan sheet.

REGISTERED PROFESSIONAL ENGINEER  
 William K. Farnbach  
 No. C49042  
 Exp. 9-30-10  
 CIVIL  
 STATE OF CALIFORNIA

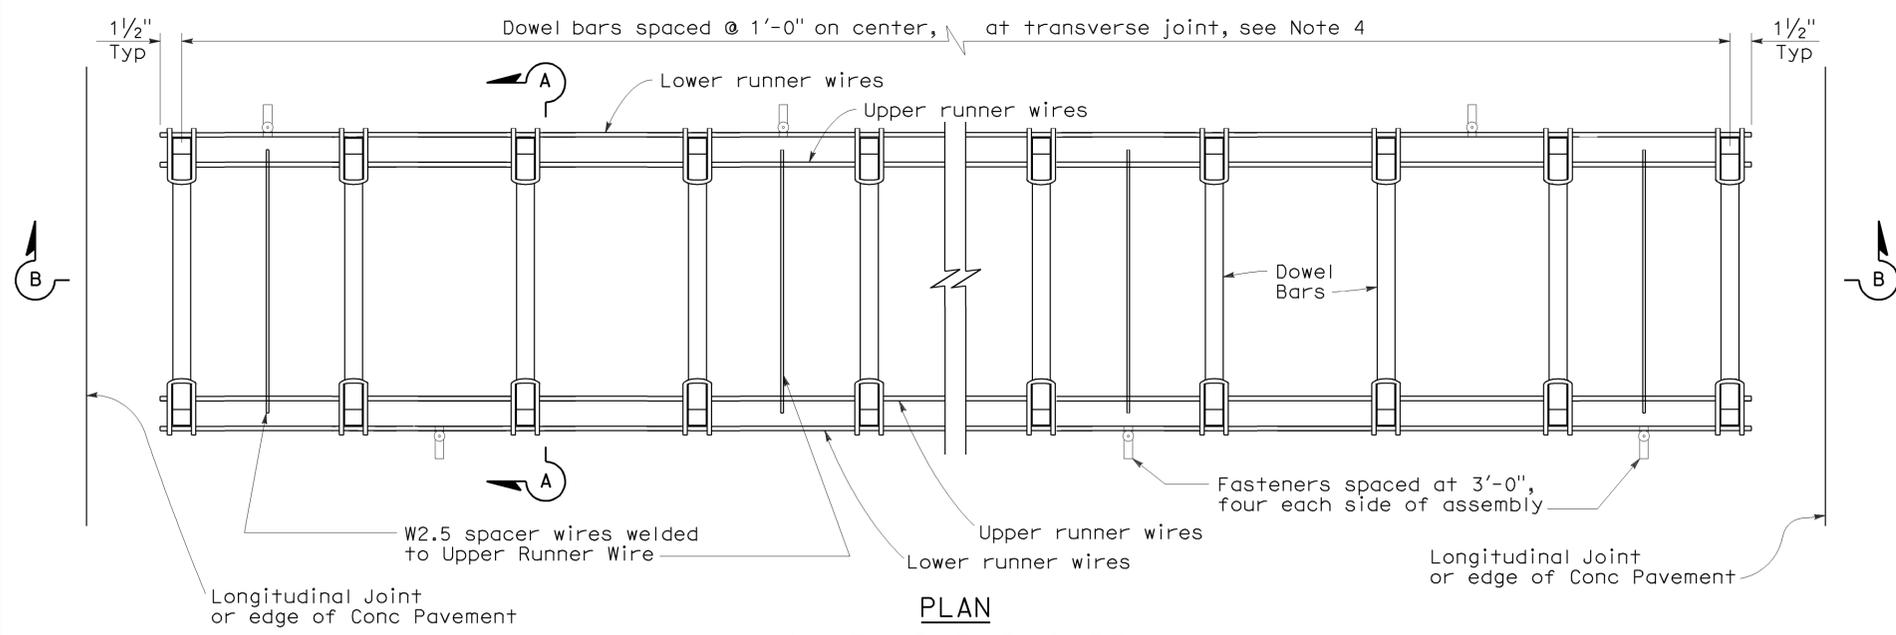
To accompany plans dated 10-04-10



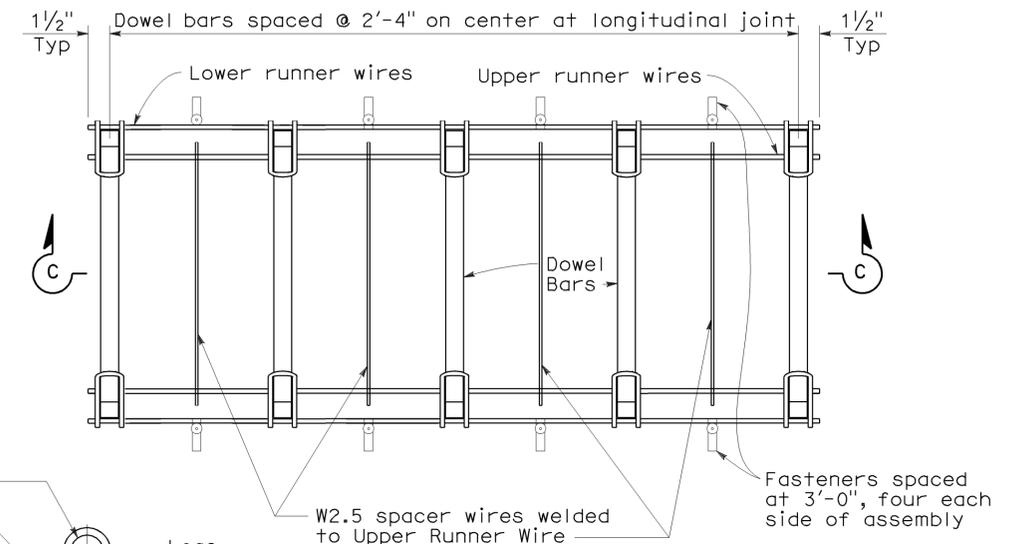
**PLAN**  
**DOWEL BAR BASKET**  
**(TRANSVERSE JOINT)**  
 See Note 1



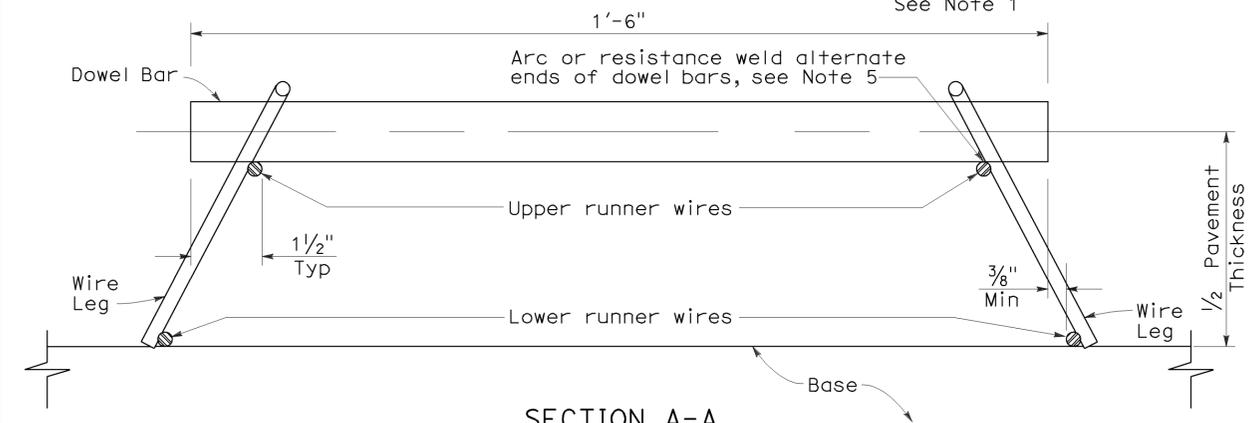
**PLAN**  
**DOWEL BAR BASKET**  
**(LONGITUDINAL JOINT)**  
 See Note 1




**SECTION A-A**

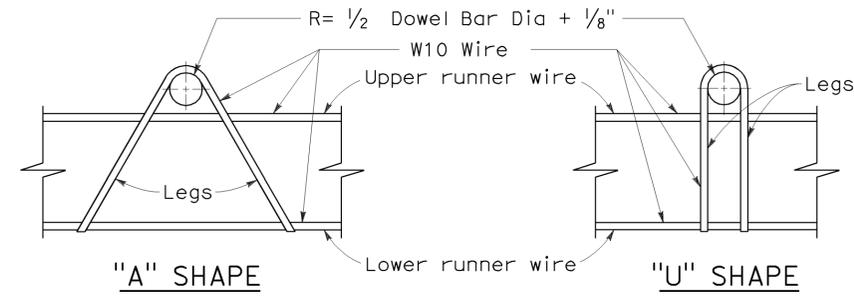


**ASSEMBLY FRAME DETAILS**

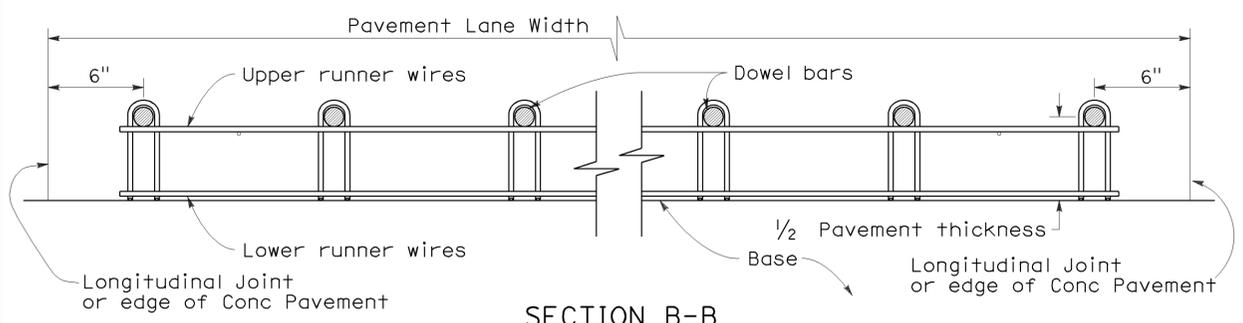

**SECTION B-B**  
 See Note 1

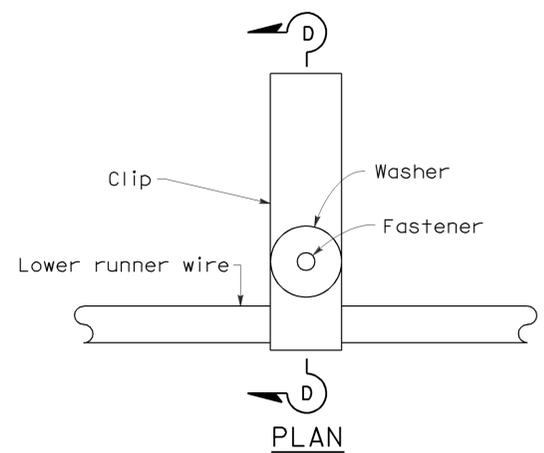

**FASTENER DETAIL**

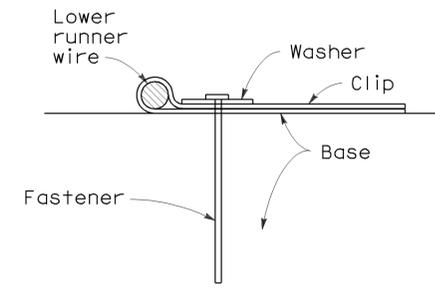

**SECTION D-D**

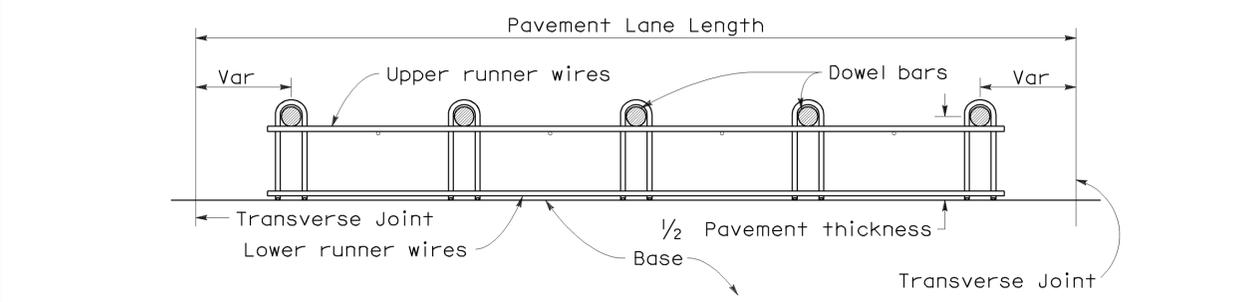
**NOTES:**

- "U" frame shape assembly shown. "U" frame shape or "A" frame shape are acceptable.
- Wire sizes shown are minimum required.
- All wire intersections are to be resistance welded.
- Use tie bar spacing for longitudinal dowel bar locations. See Revised Std Plans RSPs P1, P2, and P3 for tie bar requirements.
- Weld may be at top or bottom of dowel bar.

STATE OF CALIFORNIA  
DEPARTMENT OF TRANSPORTATION

**CONCRETE PAVEMENT-  
DOWEL BAR BASKET  
DETAILS**

NO SCALE



**SECTION C-C**  
 See Notes 1 and 4

RSP P12 DATED MAY 15, 2009 SUPERSEDES RSP P12 DATED NOVEMBER 17, 2006 AND STANDARD PLAN P12 DATED MAY 1, 2006 - PAGE 125 OF THE STANDARD PLANS BOOK DATED MAY 2006.

**REVISED STANDARD PLAN RSP P12**

2006 REVISED STANDARD PLAN RSP P12

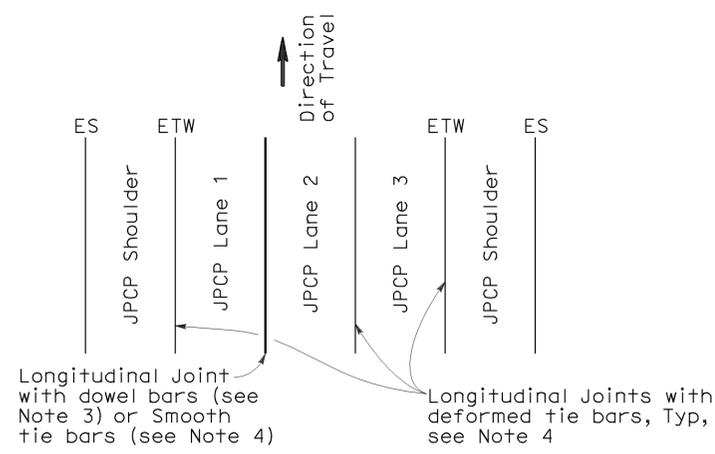
125

DIST	COUNTY	ROUTE	POST MILES TOTAL PROJECT	SHEET NO.	TOTAL SHEETS
11	SD	15	R42.5/R45.9	41	46


William K. Farnbach  
 REGISTERED CIVIL ENGINEER  
 June 5, 2009  
 PLANS APPROVAL DATE  
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REGISTERED PROFESSIONAL ENGINEER  
 William K. Farnbach  
 No. C49042  
 Exp. 9-30-10  
 CIVIL  
 STATE OF CALIFORNIA


To accompany plans dated 10-04-10



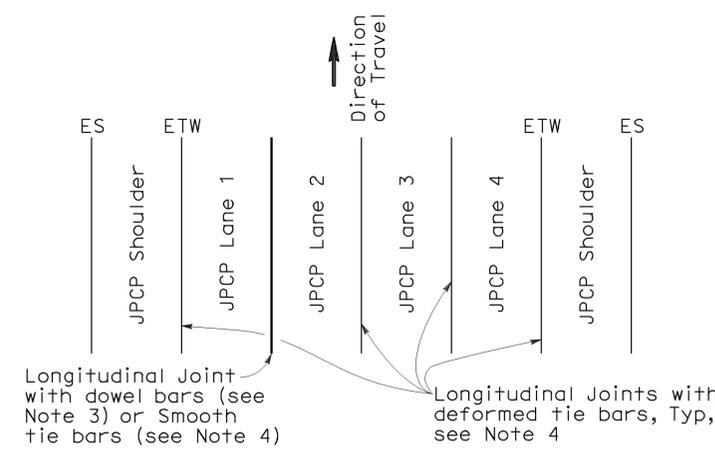**3 LANES WITH TIED CONCRETE SHOULDERS**  
PLAN



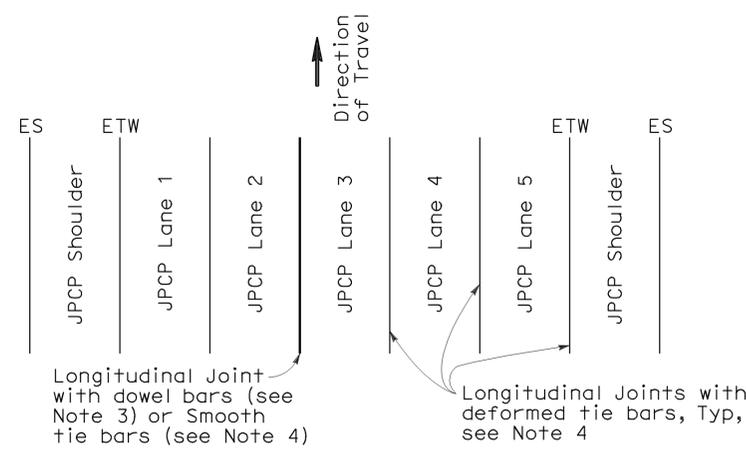
**4 LANES WITH TIED CONCRETE SHOULDERS**  
PLAN




**5 LANES WITH TIED CONCRETE SHOULDERS**  
PLAN

**NOTES:**

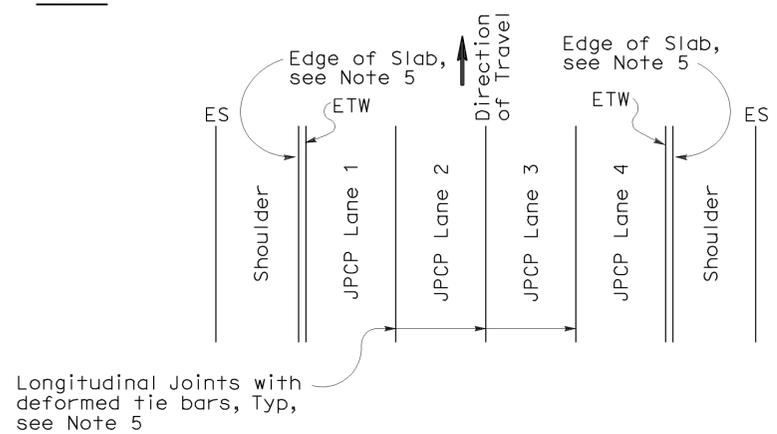- Where Lean Concrete Base is not used as base material, the joint filler material used for the longitudinal isolation joint shall only extend to the bottom of the new concrete slab. See Detail A.
- Use 5/8" ± 1/16" dimension for silicone sealant.
- See Revised Standard Plan RSP P10 for longitudinal joint with dowel bars.
- See Revised Standard Plan RSP P1.
- See Revised Standard Plan RSP P2.



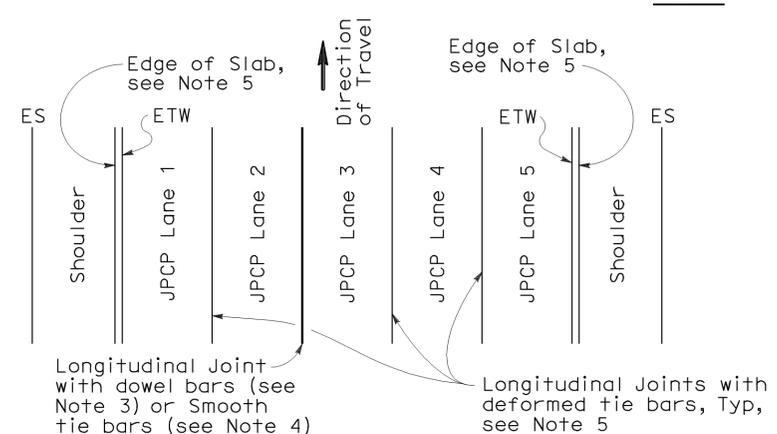
**4 LANES OR LESS WITH WIDENED SLAB**  
PLAN



**5 LANES WITH WIDENED SLAB**  
PLAN


**NEW CONSTRUCTION**

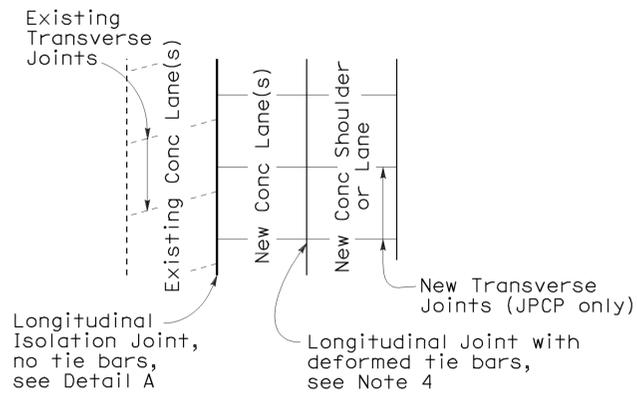Location of Longitudinal Joints (For JPCP)




**CASE 1**  
PLAN

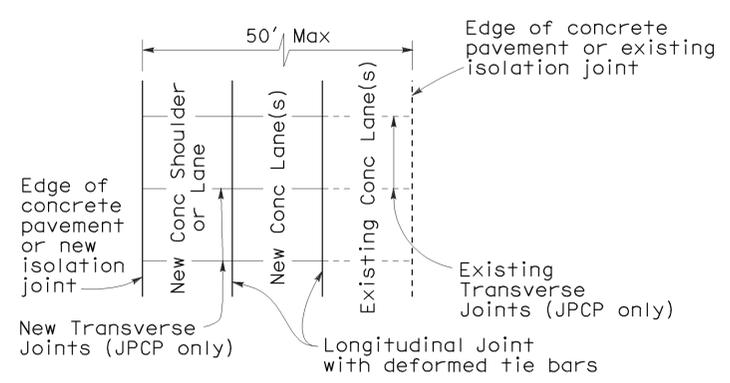Transverse Joints do not align between new and existing



**CASE 2**  
PLAN

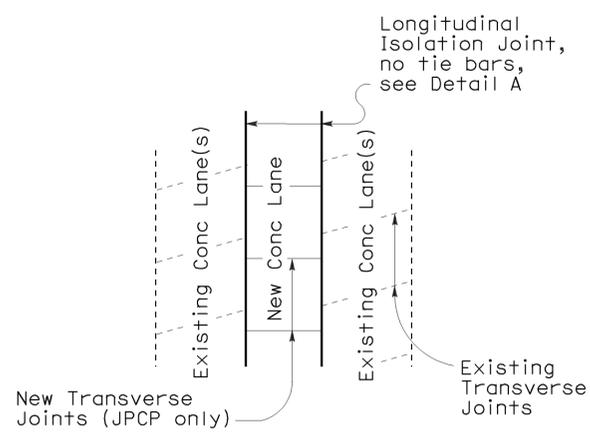
Transverse Joints align between new and existing



**CASE 3 (INTERIOR LANE REPLACEMENT)**  
PLAN

Transverse Joints do not align between new and existing

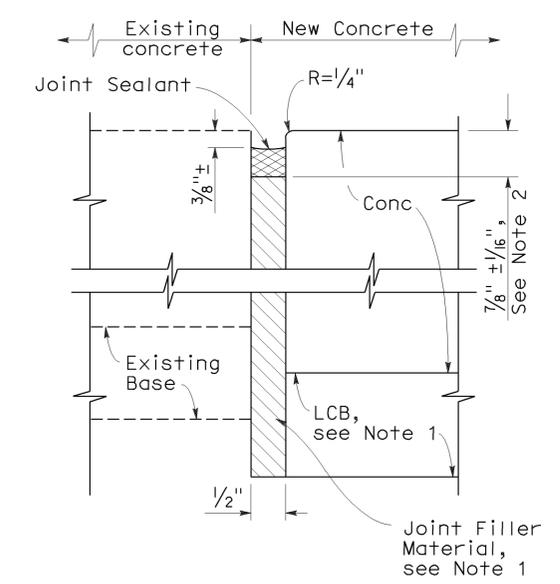**LANE/SHOULDER ADDITION OR RECONSTRUCTION**  
(For JPCP and CRCP)



**DETAIL A**  
**ISOLATION JOINT**

STATE OF CALIFORNIA  
DEPARTMENT OF TRANSPORTATION  
**CONCRETE PAVEMENT-  
LANE SCHEMATICS  
AND ISOLATION JOINT DETAIL**

NO SCALE

RSP P18 DATED JUNE 5, 2009 SUPERSEDES RSP P18 DATED MAY 15, 2009, RSP P18 DATED NOVEMBER 17, 2006 AND STANDARD PLAN P18 DATED MAY 1, 2006 - PAGE 127 OF THE STANDARD PLANS BOOK DATED MAY 2006.

**REVISED STANDARD PLAN RSP P18**

2006 REVISED STANDARD PLAN RSP P18

**NOTE:**

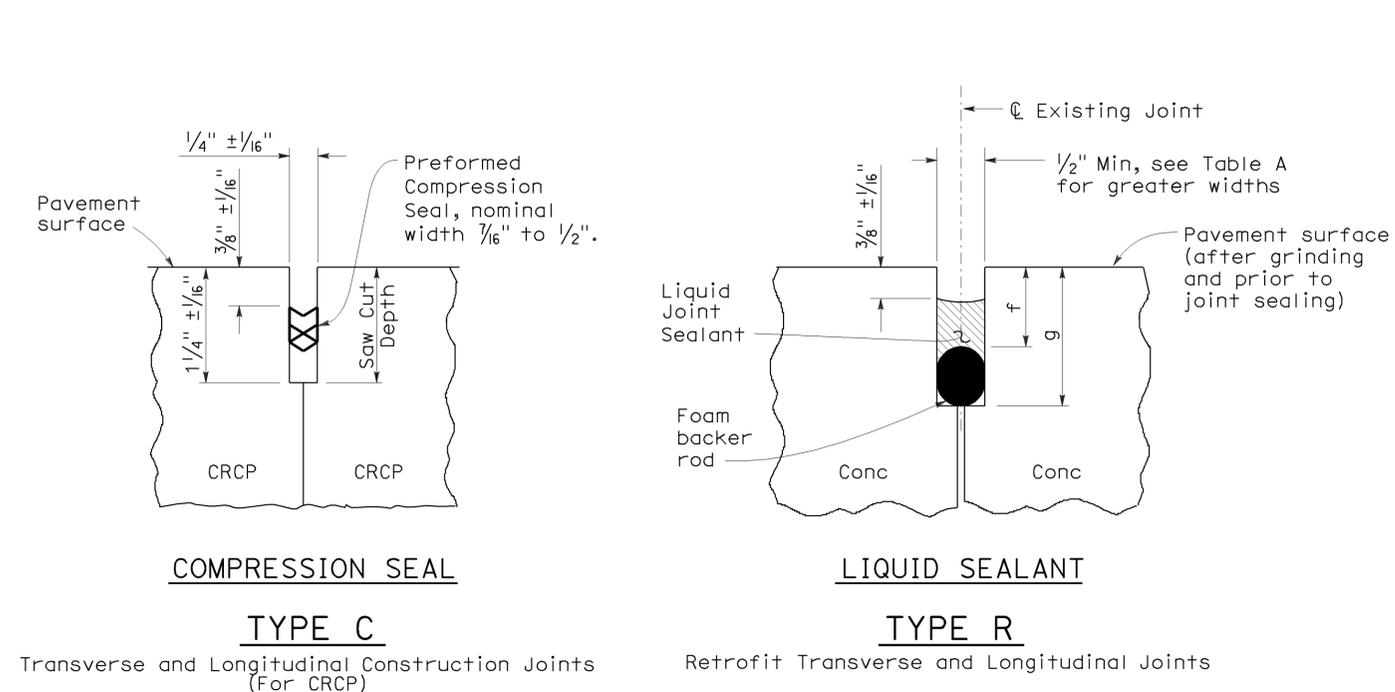
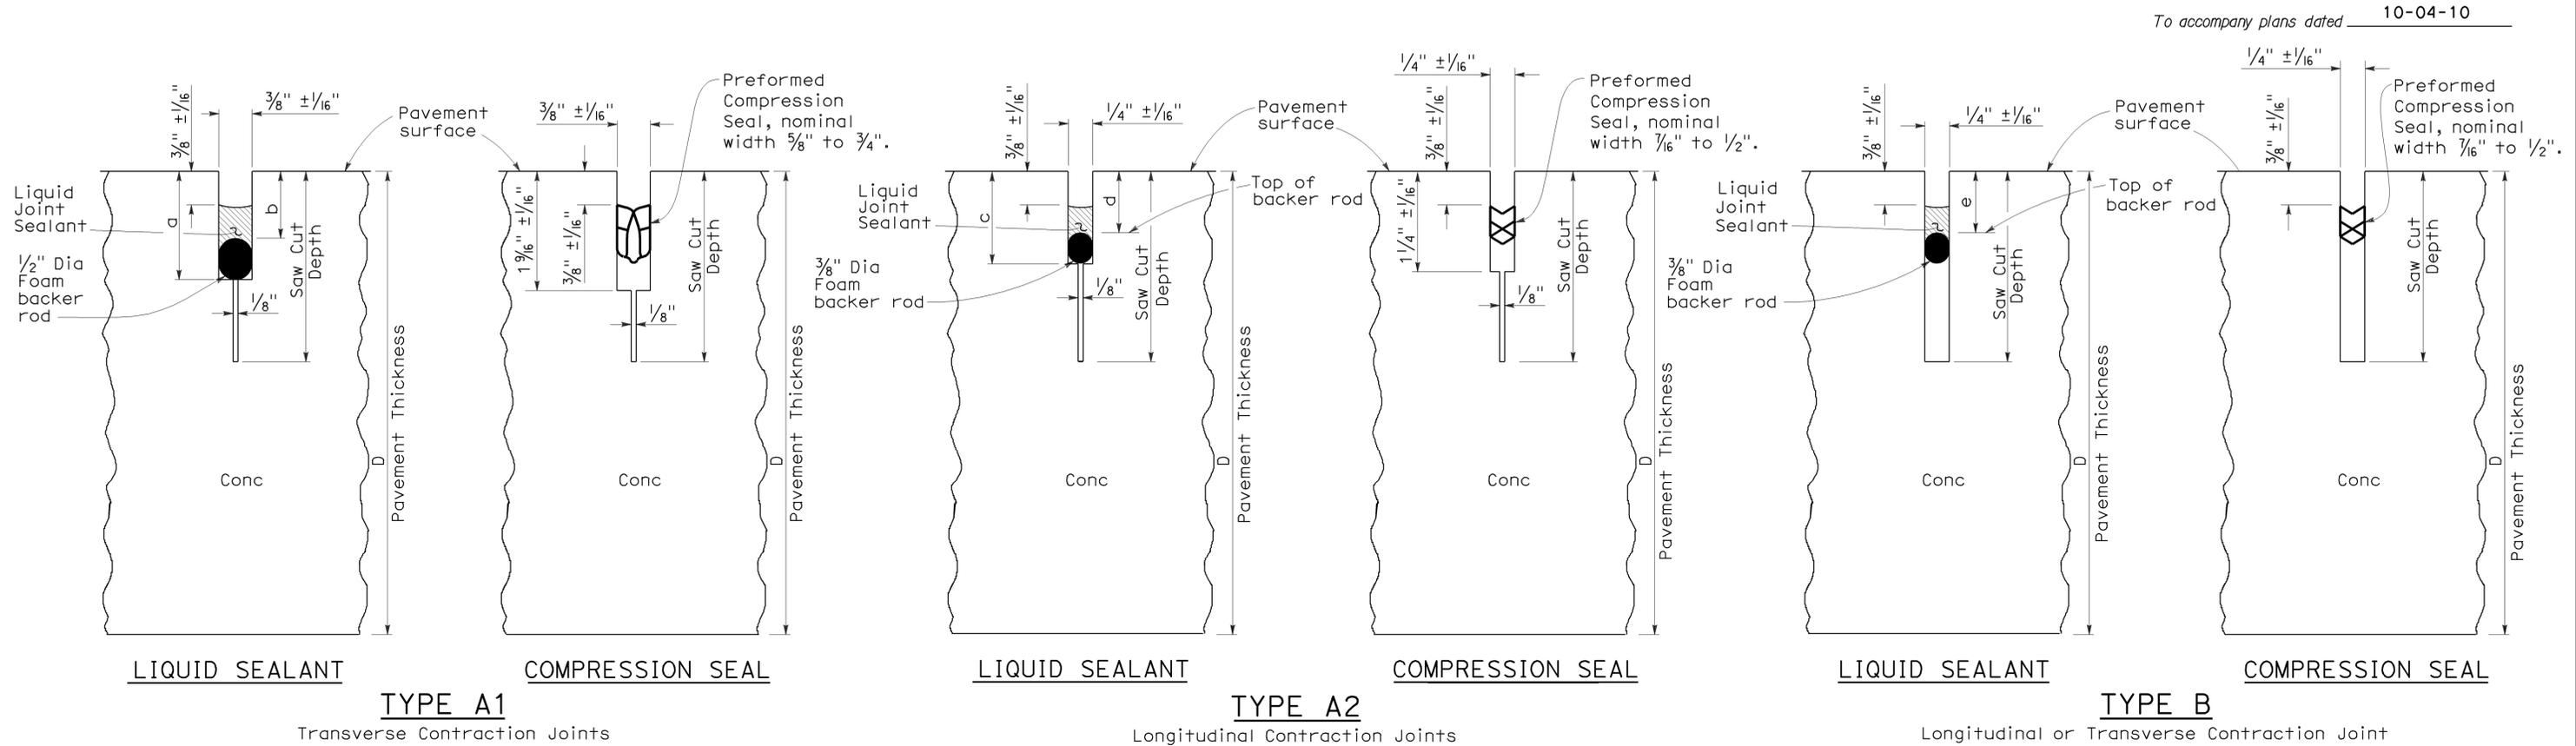
1. Tie bars, dowel bars, and reinforcement are not shown in joint seal details, see Revised Standard Plans RSP P1, RSP P3, RSP P10, RSP P35, RSP P45, or RSP P46 as applicable.

DIST	COUNTY	ROUTE	POST MILES TOTAL PROJECT	SHEET NO.	TOTAL SHEETS
11	SD	15	R42.5/R45.9	42	46

*William K. Farnbach*  
 REGISTERED CIVIL ENGINEER  
 No. C49042  
 Exp. 9-30-10  
 CIVIL  
 STATE OF CALIFORNIA

May 15, 2009  
 PLANS APPROVAL DATE

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LIQUID SEALANT RESERVOIR DEPTH

LIQUID SEALANT MATERIAL	3/8" Joint Width Type A1		1/4" Joint Width Type A2		1/4" Joint Width Type B
	DIMENSION		DIMENSION		DIMENSION
	a	b	c	d	e
SILICONE	1" ± 1/16"	5/8" ± 1/16"	15/16" ± 1/16"	9/16" ± 1/16"	9/16" ± 1/16"
ASPHALT RUBBER	1 3/16" ± 1/16"	3/4" ± 1/16"	1 1/16" ± 1/16"	11/16" ± 1/16"	11/16" ± 1/16"

TABLE A (TYPE R JOINT)

Sawn Joint Width	Backer Rod Diameter ± 1/16"	DIMENSION "f"	DIMENSION "g"
1"	1 5/16"	7/8"	2 1/4"
7/8"	1 3/16"	13/16"	2"
3/4"	1"	3/4"	1 3/4"
5/8"	7/8"	11/16"	1 1/2"
1/2"	11/16"	5/8"	1 1/4"

STATE OF CALIFORNIA  
 DEPARTMENT OF TRANSPORTATION  
**CONCRETE PAVEMENT-  
 JOINT DETAILS**  
 NO SCALE

RSP P20 DATED MAY 15, 2009 SUPERSEDES STANDARD PLAN P20  
 DATED MAY 1, 2006 - PAGE 128 OF THE STANDARD PLANS BOOK DATED MAY 2006.

**REVISED STANDARD PLAN RSP P20**

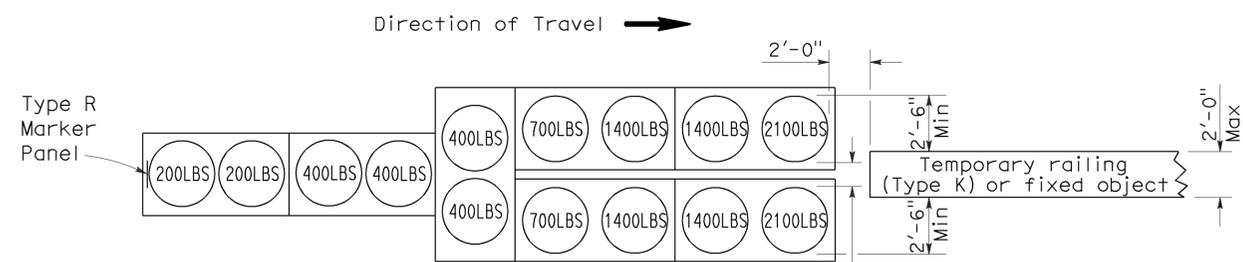
DIST	COUNTY	ROUTE	POST MILES TOTAL PROJECT	SHEET NO.	TOTAL SHEETS
11	SD	15	R42.5/R45.9	43	46

*Randell D. Hiatt*  
REGISTERED CIVIL ENGINEER

June 6, 2008  
PLANS APPROVAL DATE


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To accompany plans dated 10-04-10




**ARRAY 'TU14'**

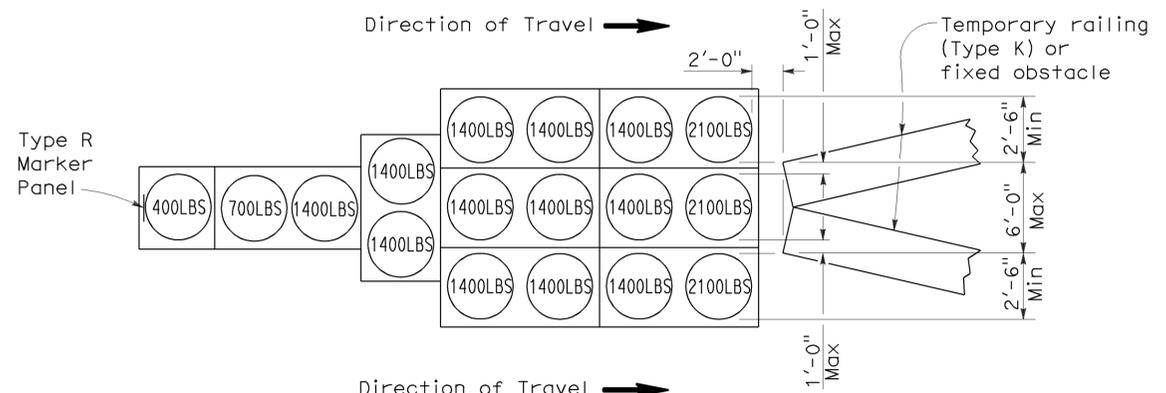Approach speed 45 mph or more




**ARRAY 'TU17'**

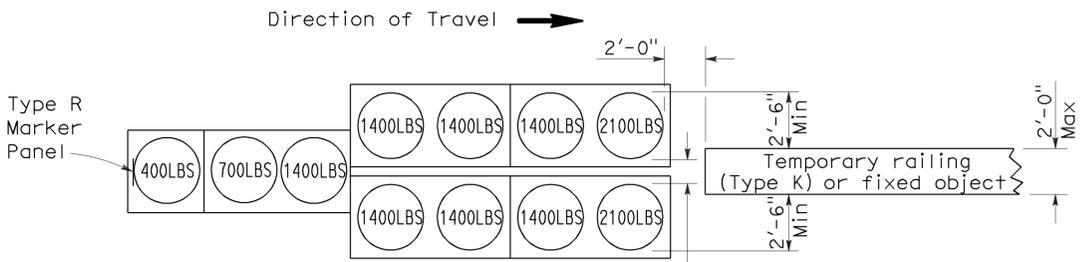Approach speed less than 45 mph




**ARRAY 'TU11'**

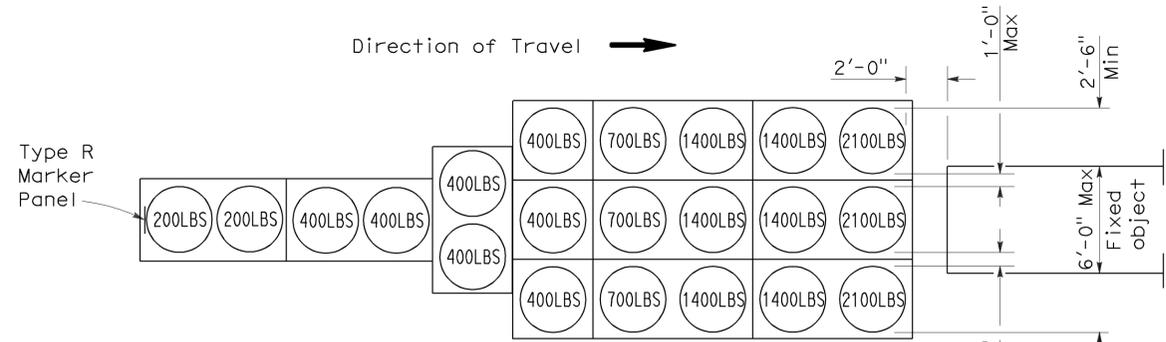Approach speed less than 45 mph




**ARRAY 'TU21'**

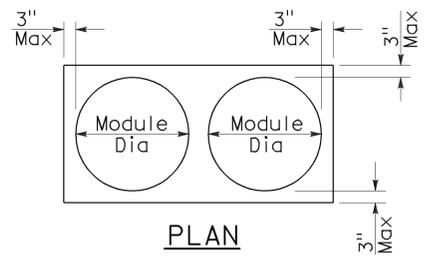Approach speed 45 mph or more



**PLAN**

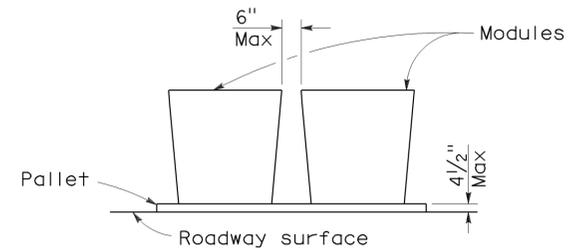

**ELEVATION**

**CRASH CUSHION PALLET DETAIL**

See Note 7

**NOTES:**

1. (XXX) Indicates sand filled module location and weight of sand in pounds for each module. Module spacing is based on the greater diameter of the module.
2. All sand weights are nominal.
3. Temporary crash cushion arrays shall not encroach on the traveled way.
4. Place the top of Type R marker panel 1" below the module lid.
5. Refer to Standard Plan A73B for marker details.
6. Approach speeds indicated conform to NCHRP 350 Report criteria.
7. Use of pallets is optional.

STATE OF CALIFORNIA  
DEPARTMENT OF TRANSPORTATION

**TEMPORARY CRASH CUSHION,  
SAND FILLED  
(UNIDIRECTIONAL)**

NO SCALE

RSP T1A DATED JUNE 6, 2008 SUPERSEDES STANDARD PLAN T1A  
DATED MAY 1, 2006 - PAGE 211 OF THE STANDARD PLANS BOOK DATED MAY 2006.

**REVISED STANDARD PLAN RSP T1A**

2006 REVISED STANDARD PLAN RSP T1A

DIST	COUNTY	ROUTE	POST MILES TOTAL PROJECT	SHEET NO.	TOTAL SHEETS
11	SD	15	R42.5/R45.9	44	46

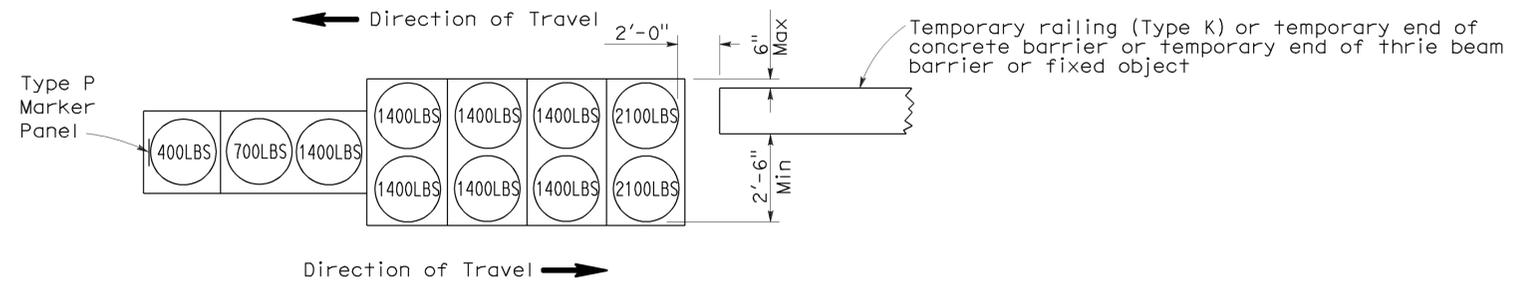
*Randell D. Hiatt*  
REGISTERED CIVIL ENGINEER

June 6, 2008  
PLANS APPROVAL DATE

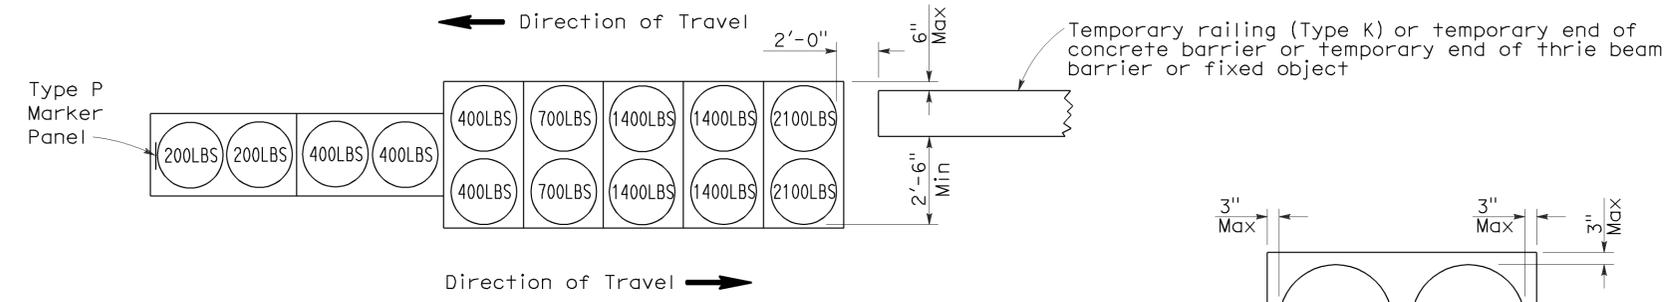
*Randell D. Hiatt*  
No. C50200  
Exp. 6-30-09  
CIVIL  
STATE OF CALIFORNIA

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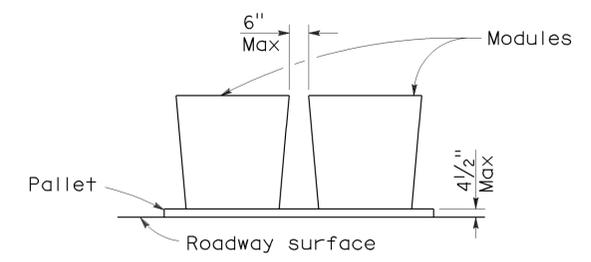
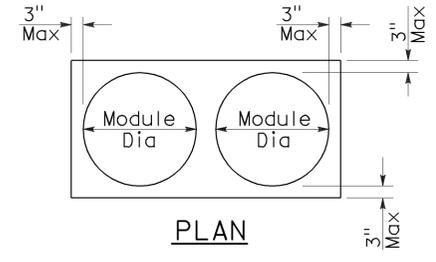
To accompany plans dated 10-04-10



**ARRAY 'TB11'**  
Approach speed less than 45 mph



**ARRAY 'TB14'**  
Approach speed 45 mph or more



**CRASH CUSHION PALLET DETAIL**  
See Note 7

**NOTES:**

1. (XXX) Indicates sand filled module location and weight of sand in pounds for each module. Module spacing is based on the greater diameter of the module.
2. All sand weights are nominal.
3. Temporary crash cushion arrays shall not encroach on the traveled way.
4. Place the Type P marker panel so that the bottom of the panel rests upon the pallet.
5. Refer to Standard Plan A73B for marker details.
6. Approach speeds indicated conform to NCHRP 350 Report criteria.
7. Use of pallets is optional.

STATE OF CALIFORNIA  
DEPARTMENT OF TRANSPORTATION

**TEMPORARY CRASH CUSHION,  
SAND FILLED  
(BIDIRECTIONAL)**

NO SCALE

RSP T1B DATED JUNE 6, 2008 SUPERSEDES STANDARD PLAN T1B  
DATED MAY 1, 2006 - PAGE 212 OF THE STANDARD PLANS BOOK DATED MAY 2006.

**REVISED STANDARD PLAN RSP T1B**

**2006 REVISED STANDARD PLAN RSP T1B**

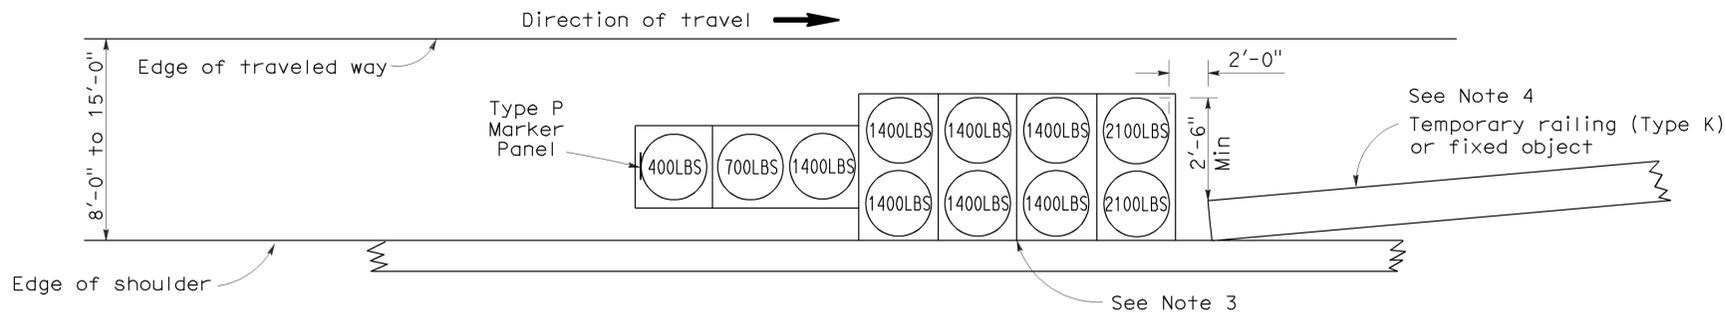
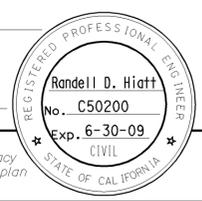
DIST	COUNTY	ROUTE	POST MILES TOTAL PROJECT	SHEET NO.	TOTAL SHEETS
11	SD	15	R42.5/R45.9	45	46

*Randell D. Hiatt*  
REGISTERED CIVIL ENGINEER


June 6, 2008  
PLANS APPROVAL DATE

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To accompany plans dated 10-04-10



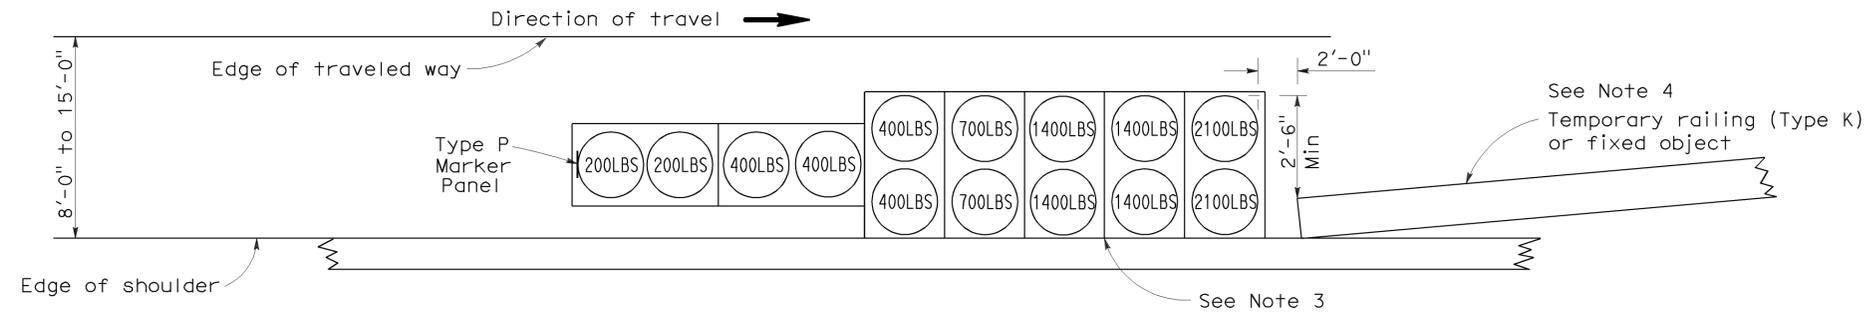
**ARRAY 'TS11'**  
Approach speed less than 45 mph  
See Note 9



**ARRAY 'TS14'**  
Approach speed 45 mph or more  
See Note 9

**NOTES:**

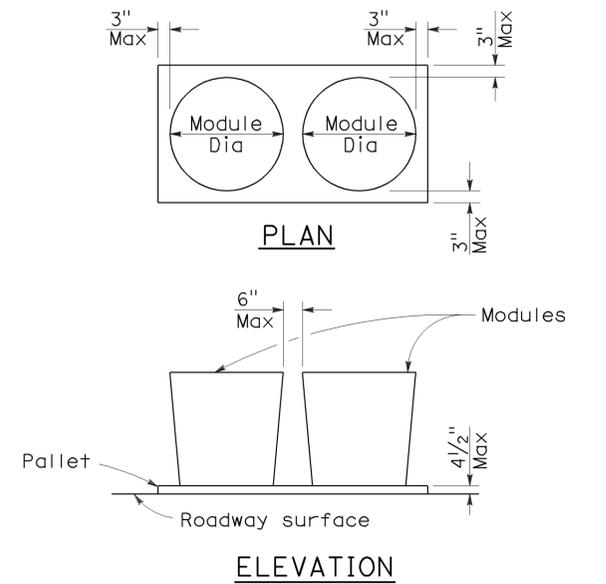- (XXX) Indicates sand filled module location and weight of sand in pounds for each module. Module spacing is based on the greater diameter of the module.
- All sand weights are nominal.
- The temporary crash cushion arrays shown on this plan shall be used only in locations where there will be traffic on one side of the temporary crash cushion array.
- If the fixed object or approach end of the temporary railing is less than 15'-0" from the edge of traveled way, a temporary crash cushion is required in a construction or work zone.
- Temporary crash cushion arrays shall not encroach on the traveled way.
- Arrays for median shoulders shall conform to details shown on this plan for outside shoulders.
- Place the Type P marker panel so that the bottom of the panel rests upon the pallet and faces traffic.
- Refer to Standard Plan A73B for marker details.
- For shoulder widths less than 8'-0", appropriate approved crash cushion protection, other than sand filled modules, shall be provided at fixed objects and at approach ends of temporary railing. The specific type of crash cushion shall be as shown on the project plans or as specified in the Special Provisions, or if not shown on the project plans or specified in the Special Provisions, shall be as approved by the Engineer.
- Approach speeds indicated conform to NCHRP 350 Report criteria.
- Use of pallets is optional.



**CRASH CUSHION PALLET DETAIL**  
See Note 11

STATE OF CALIFORNIA  
DEPARTMENT OF TRANSPORTATION  
**TEMPORARY CRASH CUSHION,  
SAND FILLED  
(SHOULDER INSTALLATIONS)**  
NO SCALE

RSP T2 DATED JUNE 6, 2008 SUPERSEDES STANDARD PLAN T2  
DATED MAY 1, 2006 - PAGE 213 OF THE STANDARD PLANS BOOK DATED MAY 2006.

**REVISED STANDARD PLAN RSP T2**

2006 REVISED STANDARD PLAN RSP T2

